

A12 Chelmsford to A120 widening scheme

Map book 3: Engineering plans (Set 2 of 4 - Junctions)

A12 Chelmsford to A120 widening scheme map books

The three map books prepared for this statutory consultation contain plans of the proposed scheme under the following headings:

- Map book 1: General arrangements (layout plans)
- Map book 2: Land use plans
- Map book 3: Engineering plans

These plans show the proposed scheme in detail to help the viewer better understand our proposals.

The plans run from junction 19 (Boreham interchange) to junction 25 (Marks Tey interchange). Identically numbered sheets in the different map books show the same area. For example, in map book 1, sheet 1 shows the layout around junction 19, and in map book 2, sheet 1 shows the land use plan around junction 19. This principle applies across all the map book 1 and map book 2 sheets but is not carried through into map book 3.

Map book 1: General arrangements

The general arrangements show the layout of the proposed scheme, including:

- Permanent works, new roads, earthworks and roadside features such as signage and lighting columns
- Environmental mitigation, landscaping and tree planting

- Provisional order limits (also known as the red line boundary)
- Open space and replacement land

Map book 2: Land use plans

The land use plans show the areas where we are seeking powers to acquire land and rights permanently. They also show the land we require for a temporary period to construct the proposed scheme. We may need the land permanently for:

- road alignments
- junction improvements
- environmental mitigation
- drainage

Permanent works

Purchase of land or acquisition of permanent rights will be required for the route of the road, to reconnect local roads and for associated structures like drainage ponds.

Permanent rights

Land used temporarily for construction and thereafter required for the creation of new permanent rights for example, to maintain the proposed scheme including the highway and associated apparatus, for rights of access or for rights to operate and maintain new statutory undertaker apparatus. It may also be required where existing rights

need to be acquired, suspended, changed or extinguished to construct and operate the proposed scheme.

Temporary works


Temporary use of land is needed for the proposed scheme to be constructed safely. The plans show land that may be required temporarily for the main construction compounds at various locations along the route. We will also require temporary access over land to divert utilities such as gas pipelines, electricity cables and water pipes. Any land that is only required temporarily will be returned to its previous use wherever possible once construction is complete.


Map book 3: Engineering plans


These plans show the highway details of the route in a 'plan and profile' (level above or below existing ground) format. The drawings are split into two views, with the plan on the top and the profile underneath.

The profile shows the road level in relation to the existing ground at given distances along the route, referred to as chainages. An exaggerated scale is used in the profile to help show the differences in levels and slopes of the design. The profile also shows where existing roads and public rights of way cross over or under the route.

All levels are given in relation to sea level. As is the standard approach on engineering projects, sea level is taken from a reference point at Newlyn in Cornwall. The profile reference level might be different on each drawing.

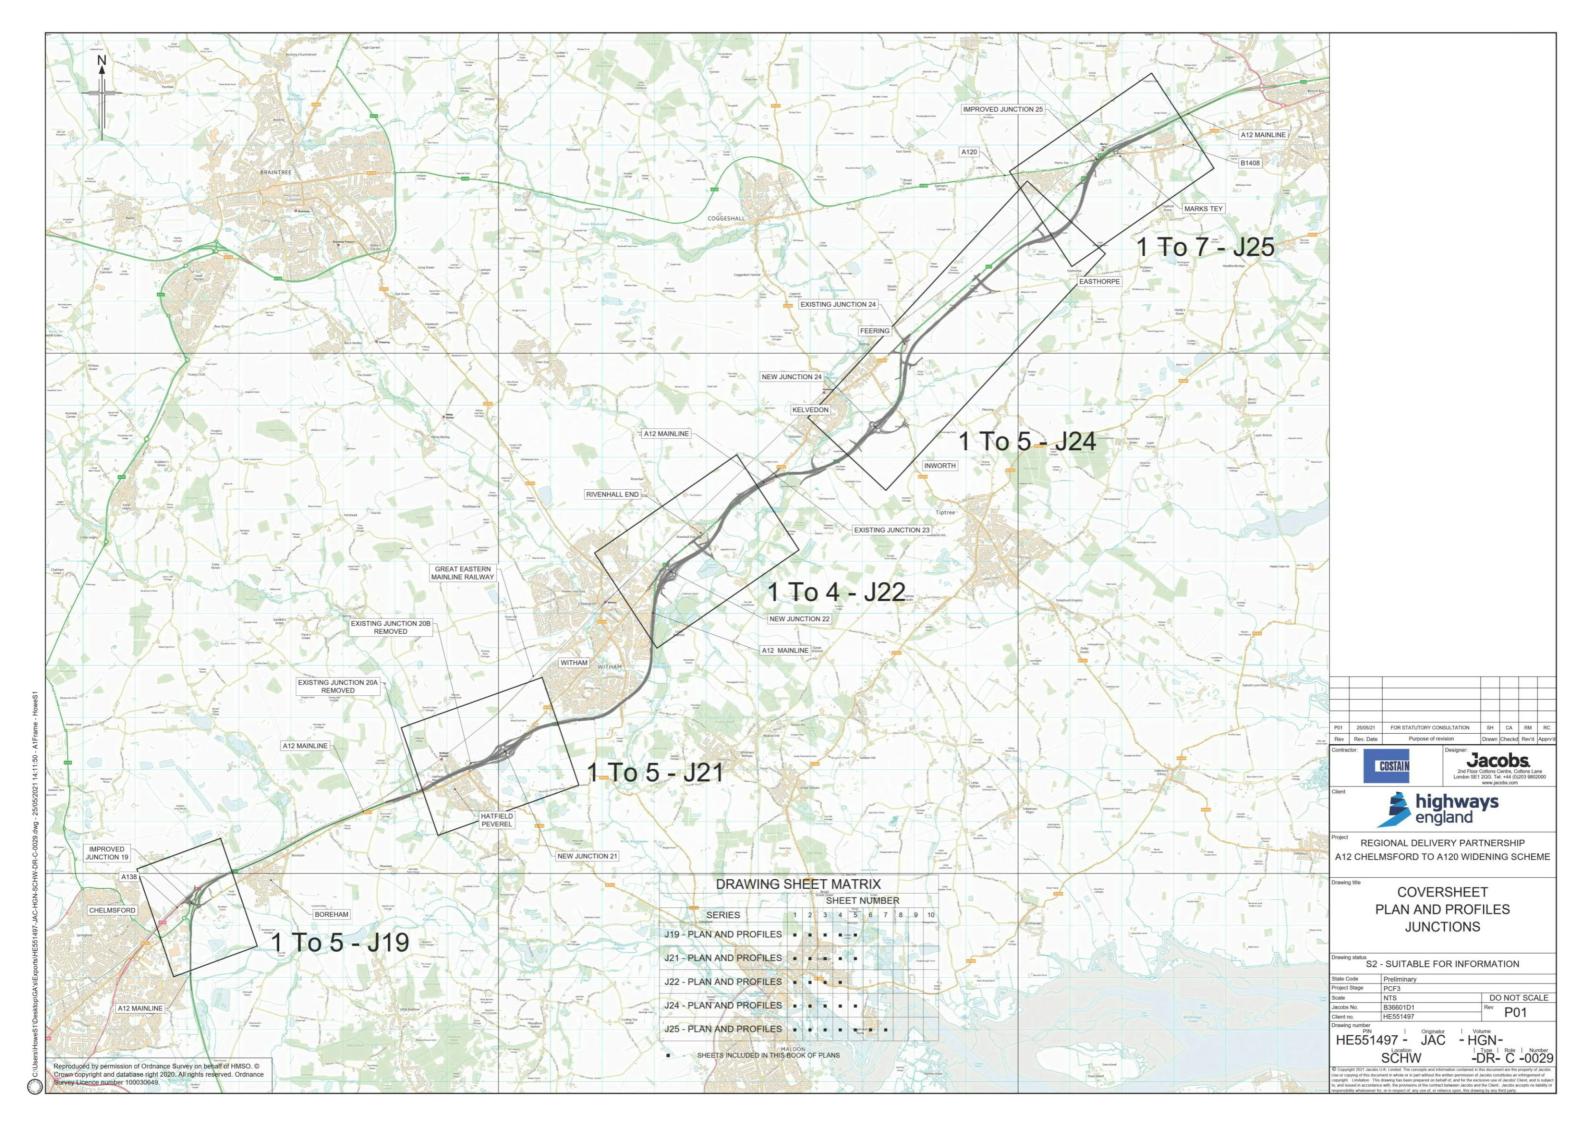

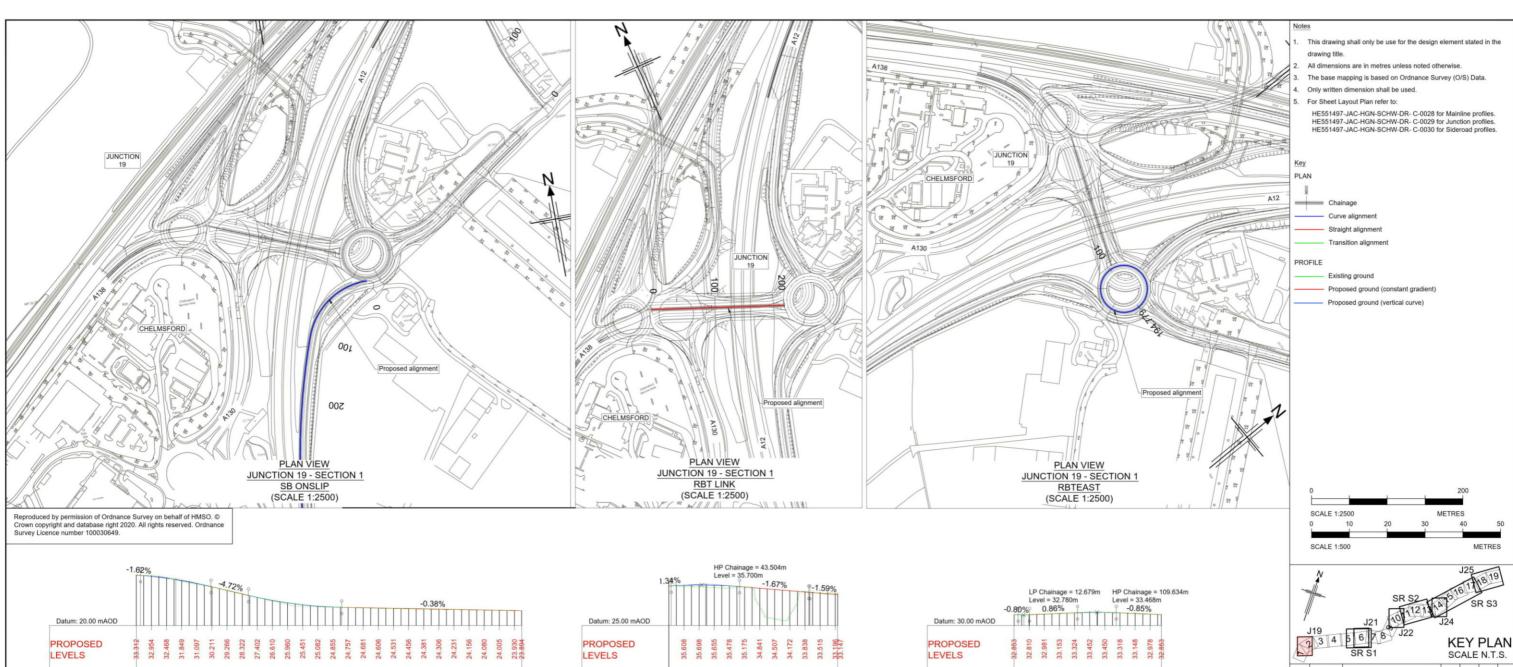

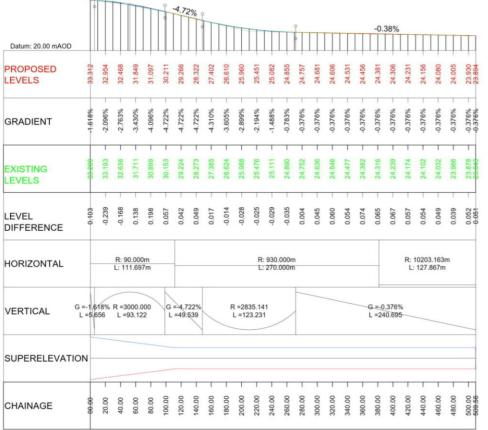


LONGITUDINAL SECTION

JUNCTION 19 - SECTION 1 - SB ONSLIP

(SCALE H=1:2500, V =1:500)

GRADIENT EXISTING LEVELS LEVEL DIFFERENCE HORIZONTAL L =223.058m R =2000,000 G = 1.671% L =1.526 L =91.367 R =3000.000 L =90.359 VERTICAL SUPERELEVATION CHAINAGE

> LONGITUDINAL SECTION JUNCTION 19 - SECTION 1 - RBTEAST (SCALE H=1:2500, V =1:500)

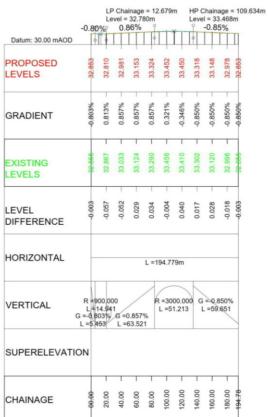

DO NOT SCALE HE551497

HE551497 - JAC - HSR-

 P02
 20/05/21
 FOR STATUTORY CONSULTATION

 Rev
 Rev. Date
 Purpose of revision

Jacobs.

P02

-DR- C -0001 S1 J19

highways england


REGIONAL DELIVERY PARTNERSHIP

A12 CHELMSFORD TO A120 WIDENING SCHEME


PLAN AND PROFILE

JUNCTION 19 SECTION 1 SB ONSLIP RBT LINK RBTEAST SHEET 1 OF 5

S2 - SUITABLE FOR INFORMATION

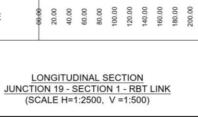


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LONGITUDINAL SECTION

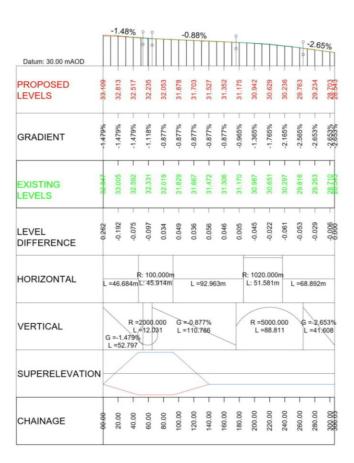JUNCTION 19 - SECTION 1 - MAINROAD


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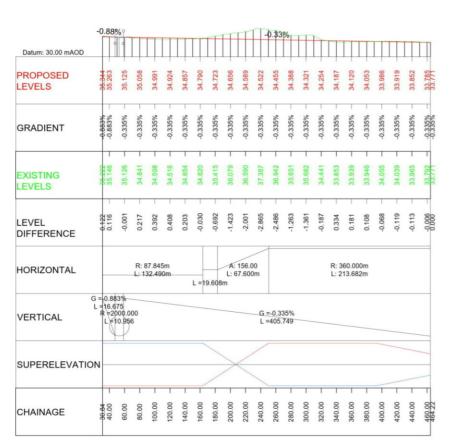


LONGITUDINAL SECTION

JUNCTION 19 - SECTION 1 - SB OFFSLIP

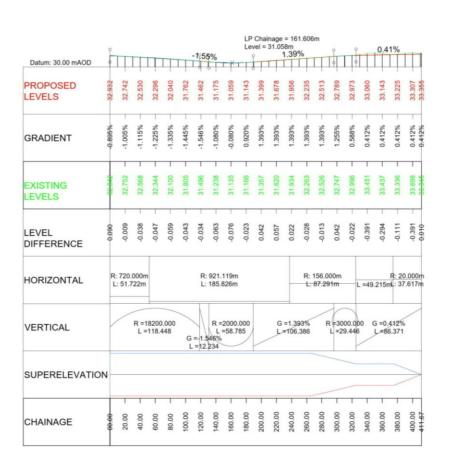(SCALE H=1:2500, V=1:500)




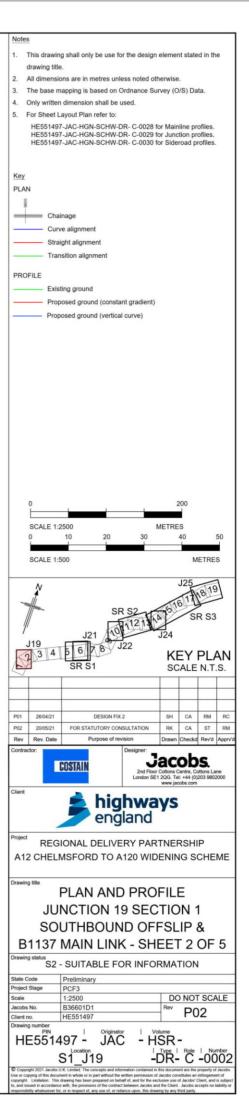

LONGITUDINAL SECTION


JUNCTION 19 - SECTION 1 - RBTWEST A12 LINK

(SCALE H=1:2500, V =1:500)

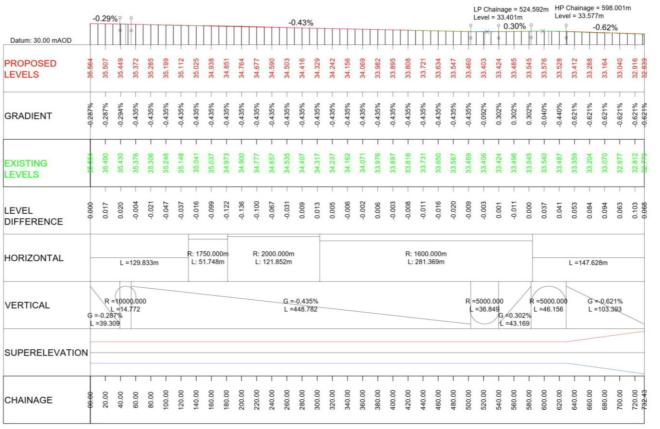

LONGITUDINAL SECTION JUNCTION 19 - SECTION 1 - NB ONSLIP (SCALE H=1:2500, V =1:500)

The base mapping is based on Ordnance Survey (O/S) Data. HE551497-JAC-HGN-SCHW-DR- C-0028 for Mainline profiles. HE551497-JAC-HGN-SCHW-DR- C-0029 for Junction profiles. HE551497-JAC-HGN-SCHW-DR- C-0030 for Sideroad profiles. Proposed ground (constant gradient) METRES **KEY PLAN** SCALE N.T.S. Jacobs. highways england REGIONAL DELIVERY PARTNERSHIP A12 CHELMSFORD TO A120 WIDENING SCHEME PLAN AND PROFILE **JUNCTION 19 SECTION 1** NORTHBOUND ONSLIP & RBTWEST A12LINK - SHEET 3 OF 5 S2 - SUITABLE FOR INFORMATION Preliminary PCF3 1:2500 B36601D1 HE551497 DO NOT SCALE P02 HE551497 - JAC - HSR--DR- C -0003

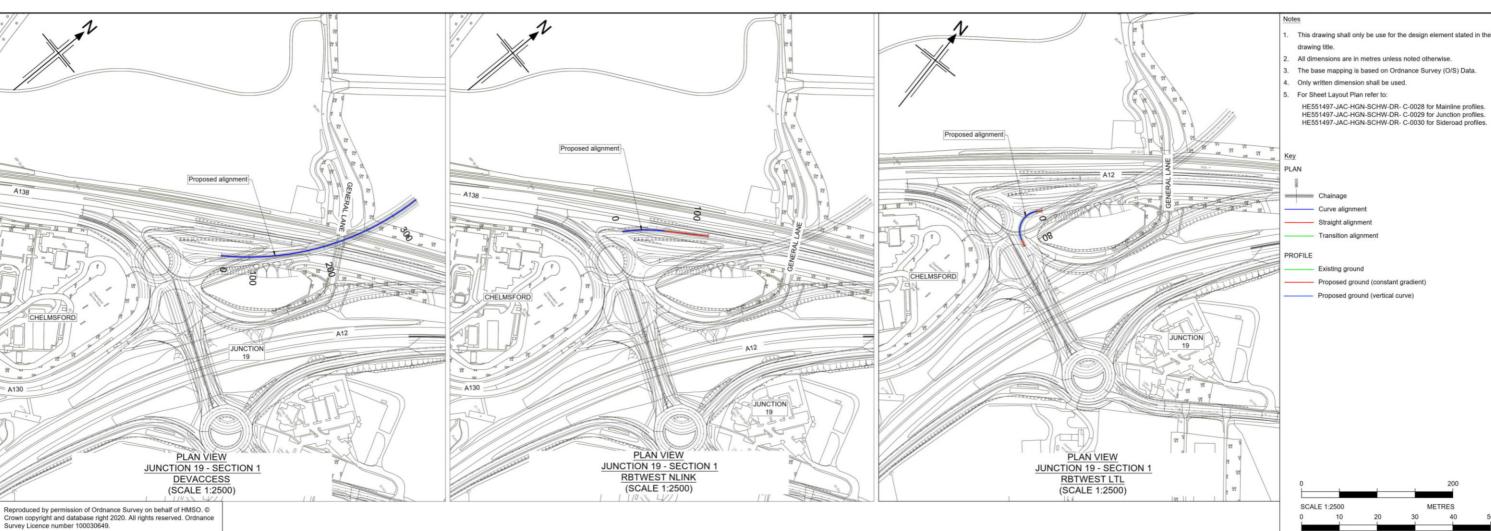

HP Chainage = 241.70 Level = 46.193m 4.40% Datum: 30.00 mAOD PROPOSED LEVELS GRADIENT **EXISTING** LEVELS LEVEL DIFFERENCE HORIZONTAL =45.128m R =1300.000 L =80.034 R =1700.000 G =-4,401 L =20,61; VERTICAL SUPERELEVATION CHAINAGE


> LONGITUDINAL SECTION JUNCTION 19 - SECTION 1 - DEVACCESS (SCALE H=1:2500, V =1:500)

Datum: 35.00 mAOD		4	-(0.16	%	-	
PROPOSED LEVELS	35.475	35,443	35.412	35,380	35.348	35.316	35.284
GRADIENT	-0.159%	-0.159%	-0.159%	-0.159%	-0.159%	-0.159%	-0.159%
	+	T	T	Т	Т	Т	┪
EXISTING LEVELS	36.95	35,879	35.671	35.516	35.406	35,365	96.300
	+	T		T		1	+
LEVEL DIFFERENCE	-0.446	-0.436	-0.260	-0.137	-0.058	-0.049	-0.025
HORIZONTAL		R: 210 L: 60			L =58	.853r	n
VERTICAL				-0.15		_	
SUPERELEVATIO	ON						
		1		1	80.00	00.00	

LONGITUDINAL SECTION JUNCTION 19 - SECTION 1 - RBTWEST NLINK (SCALE H=1:2500, V =1:500)


Datum: 35.00 mAOD	.3	7%		0.51	1%
PROPOSED LEVELS	Ι.		35.628	_	36.377
GRADIENT	4.36776	-3.467% -	-1.467% -	-0.514% -	-0.514%
EXISTING LEVELS		T			
LEVEL DIFFERENCE		0.000	0.000	0.000	0.000
HORIZONTAL =7	H		.000r .184n L	n	584m
	10.	974 =10	G L 00.00 8.530	±30. 0	
SUPERELEVATION					
CHAINAGE	90.00	20.00	40.00	- 00.09	79.92


LONGITUDINAL SECTION JUNCTION 19 - SECTION 1 - RBTWEST LTL (SCALE H=1:2500, V =1:500)

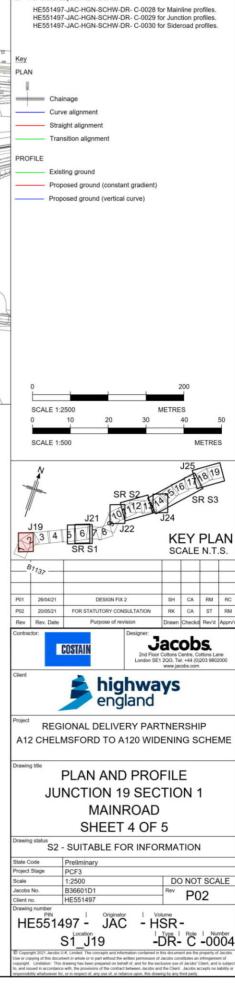


METRES

P02

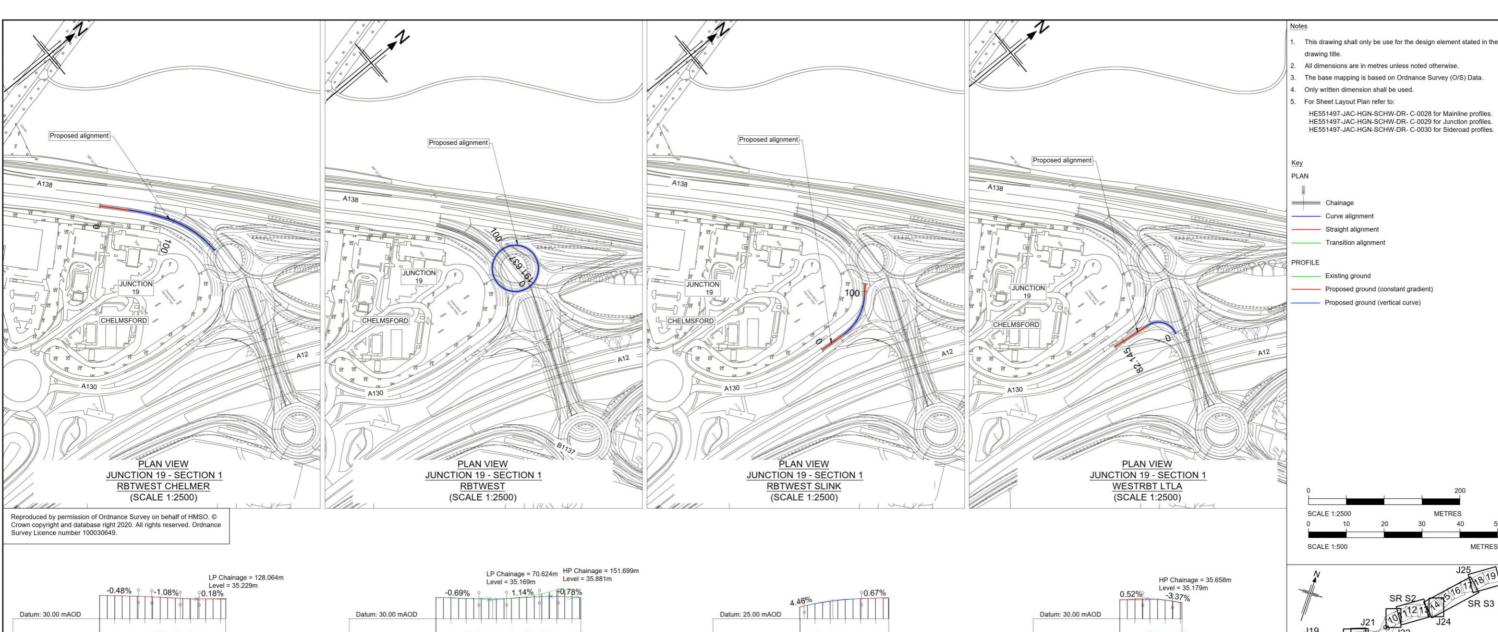


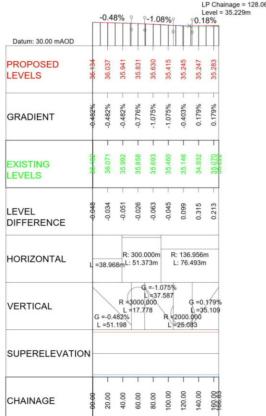


LONGITUDINAL SECTION
JUNCTION 19 - SECTION 1 - RBTWEST CHELMER (SCALE H=1:2500, V =1:500)

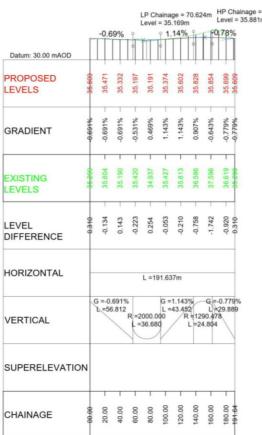


LONGITUDINAL SECTION JUNCTION 19 - SECTION 1 - RBTWEST (SCALE H=1:2500, V =1:500)

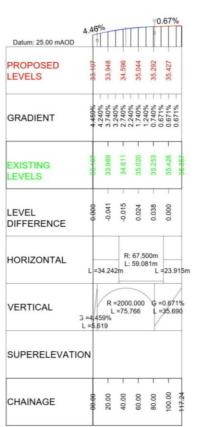

LONGITUDINAL SECTION JUNCTION 19 - SECTION 1 - RBTWEST SLINK (SCALE H=1:2500, V =1:500)

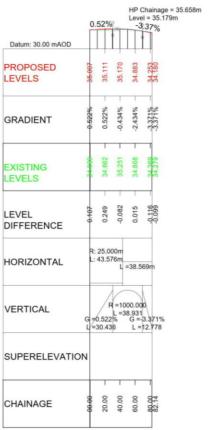

LONGITUDINAL SECTION JUNCTION 19 - SECTION 1 - WESTRBT LTLA (SCALE H=1:2500, V =1:500)

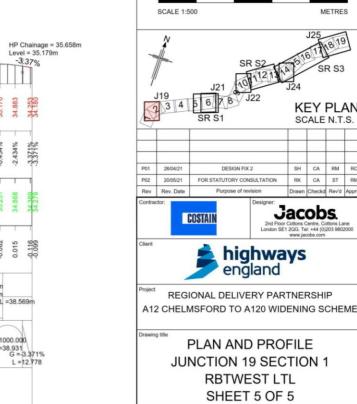

- HSR -

S2 - SUITABLE FOR INFORMATION


HE551497 HE551497 - JAC


S1 J19

KEY PLAN

SCALE N.T.S.

DO NOT SCALE P02

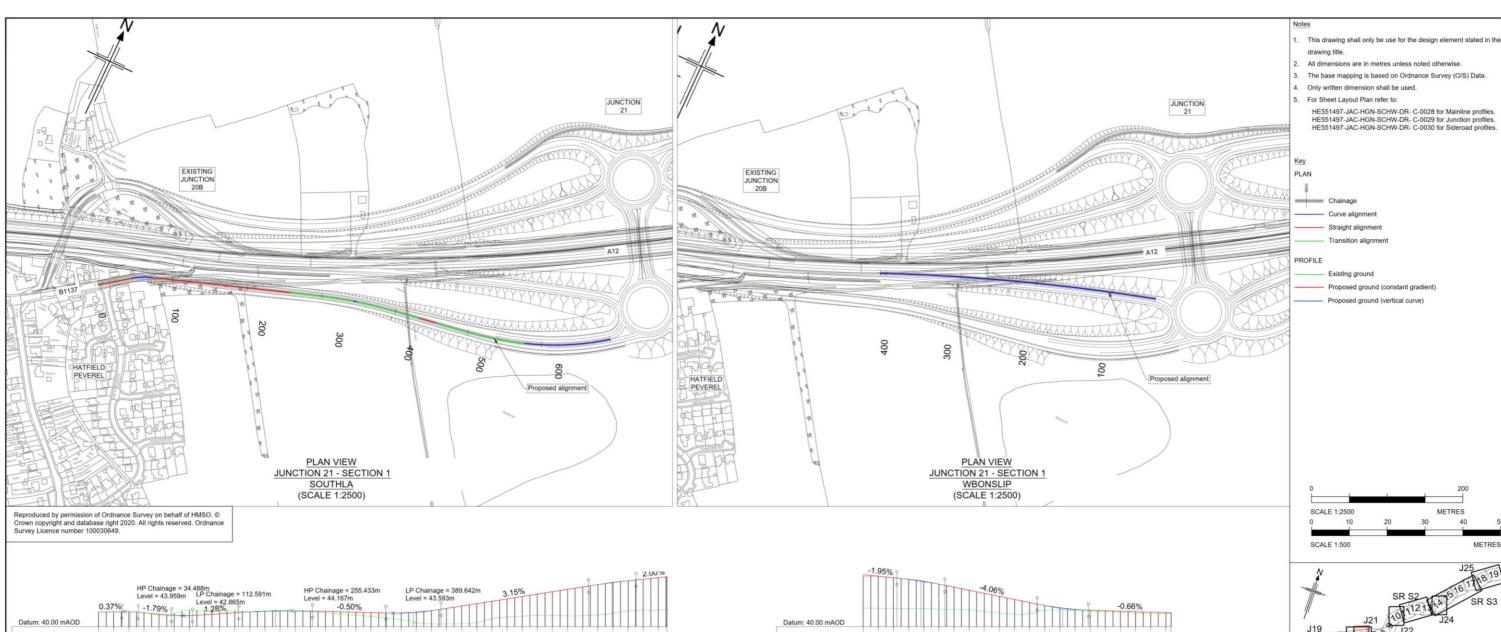


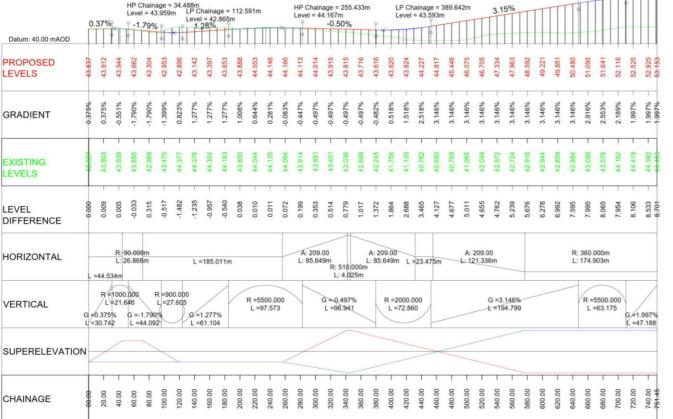

LONGITUDINAL SECTION

JUNCTION 21 - SECTION 1 - SOUTHLA


(SCALE H=1:2500, V =1:500)

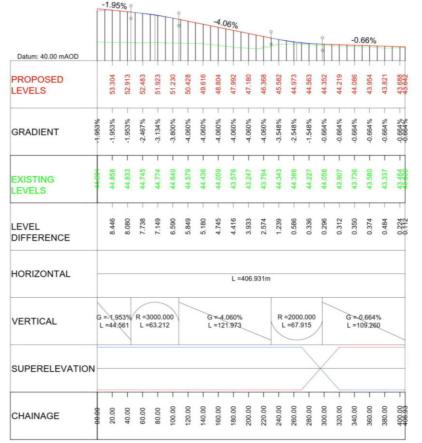

LONGITUDINAL SECTION

JUNCTION 21 - SECTION 1 - WBONSLIP

(SCALE H=1:2500, V=1:500)

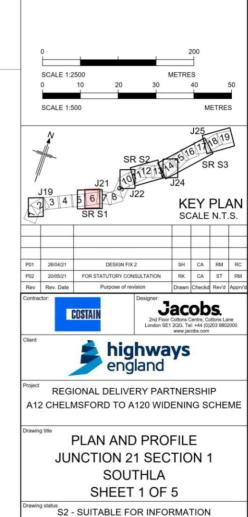


HE551497

S1 J21


HE551497 - JAC - HSR-

DO NOT SCALE

Rev P02

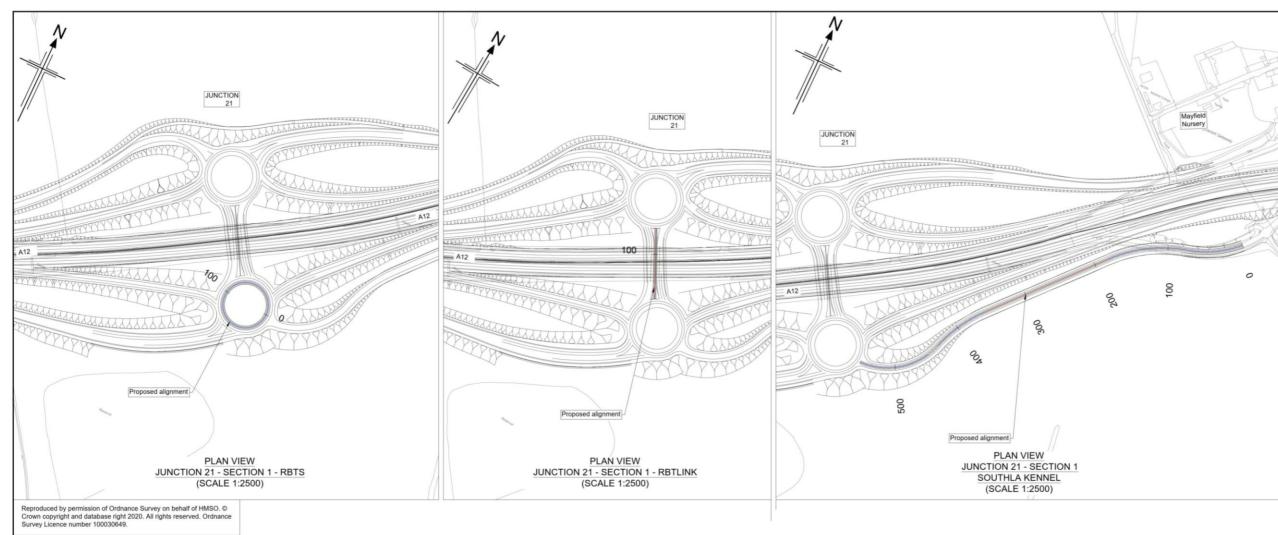


LONGITUDINAL SECTION
JUNCTION 21 - SECTION 1 - RBTS
(SCALE H=1:2500, V=1:500)

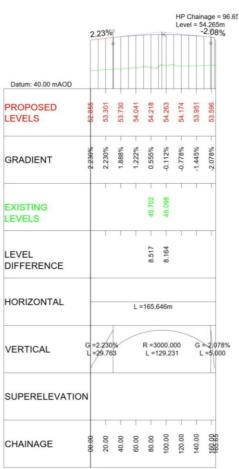

LONGITUDINAL SECTION

JUNCTION 21 - SECTION 1 - RBTLINK

(SCALE H=1:2500, V =1:500)

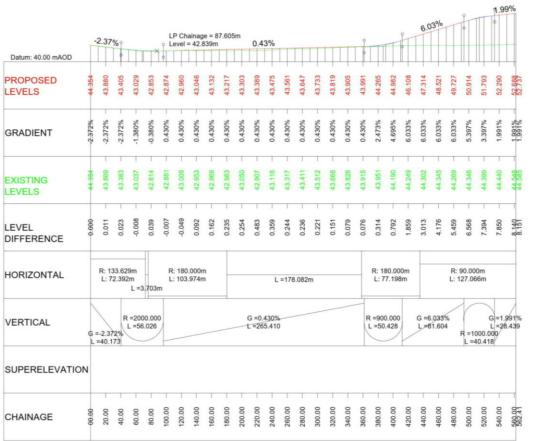

LONGITUDINAL SECTION

JUNCTION 21 - SECTION 1 - SOUTHLA KENNEL

(SCALE H=1:2500, V=1:500)



1. This drawing shall only be use for the design element stated in the

HE551497-JAC-HGN-SCHW-DR- C-0028 for Mainline profiles. HE551497-JAC-HGN-SCHW-DR- C-0029 for Junction profiles. HE551497-JAC-HGN-SCHW-DR- C-0030 for Sideroad profiles.

All dimensions are in metres unless noted otherwise.
 The base mapping is based on Ordnance Survey (O/S) Data.


Only written dimension shall be used.
 For Sheet Layout Plan refer to:

Curve alignment
Straight alignment
Transition alignment

Existing ground

Proposed ground (constant gradient)
Proposed ground (vertical curve)

drawing title.

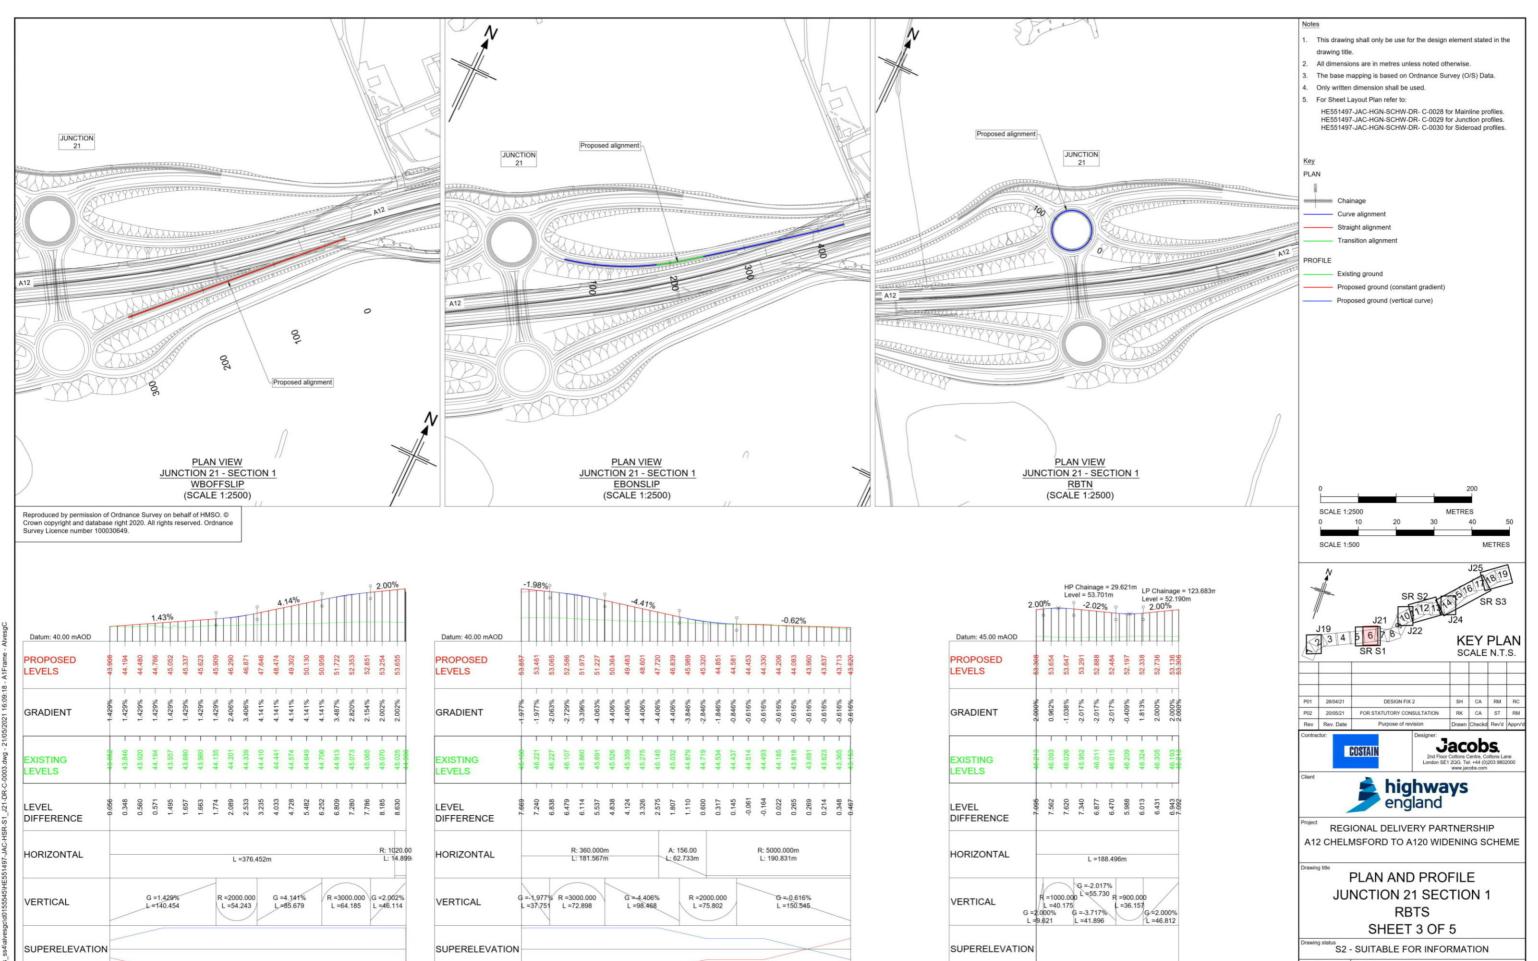

CHAINAGE

LONGITUDINAL SECTION

JUNCTION 21 - SECTION 1 - WBOFFSLIP

(SCALE H=1:2500, V =1:500)

LONGITUDINAL SECTION

JUNCTION 21 - SECTION 1 - EBONSLIP

(SCALE H=1:2500, V =1:500)

CHAINAGE

JUNCTION 21 - SECTION 1 - RBTN (SCALE H=1:2500, V =1:500)

LONGITUDINAL SECTION

CHAINAGE


HE551497 - JAC - HSR-S1 J21


HE551497

-DR- C -0003


DO NOT SCALE

P02

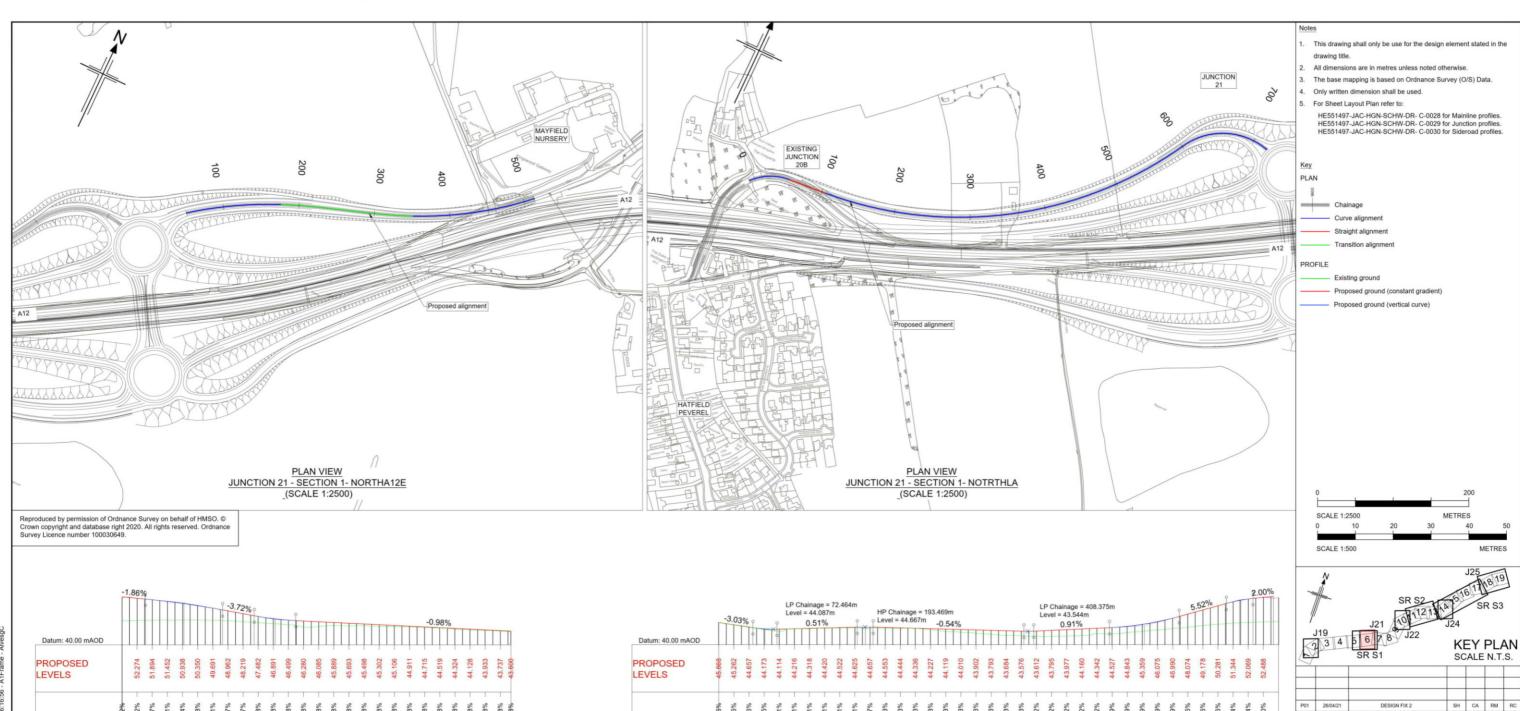

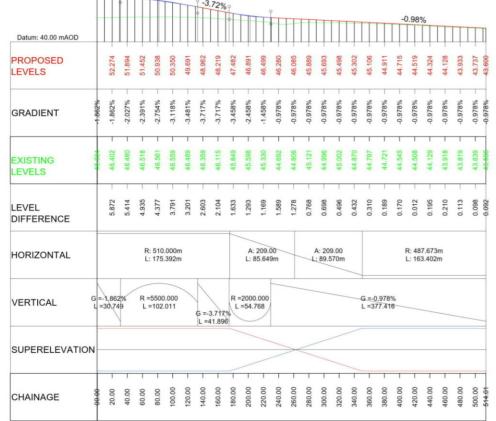

LONGITUDINAL SECTION
JUNCTION 21 - SECTION 1 - NORTHA12E (SCALE H=1:2500, V =1:500)

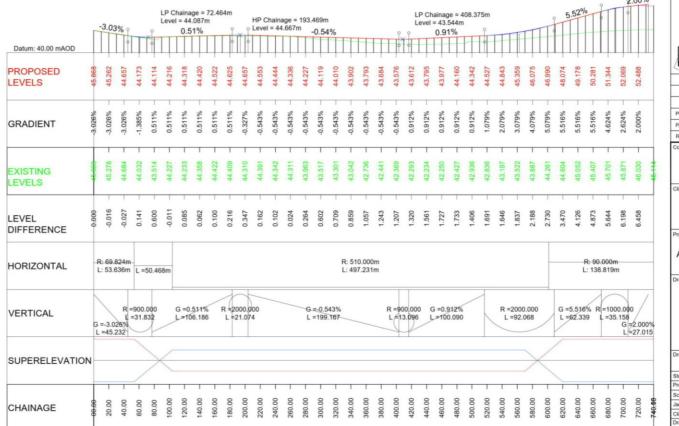

LONGITUDINAL SECTION
JUNCTION 21 - SECTION 1 - NOTRTHLA (SCALE H=1:2500, V =1:500)

Jacobs.

highways england

REGIONAL DELIVERY PARTNERSHIP A12 CHELMSFORD TO A120 WIDENING SCHEME


> PLAN AND PROFILE JUNCTION 21 SECTION 1 **RBTLINK** SHEET 4 OF 5

S2 - SUITABLE FOR INFORMATION

Preliminary	
PCF3	
1:2500	DO NOT SCALE
B36601D1	Rev PO2
HE551497	P02
	PCF3 1:2500 B36601D1

HE551497 - JAC - HSR-

-DR- C -0004 S1 J21

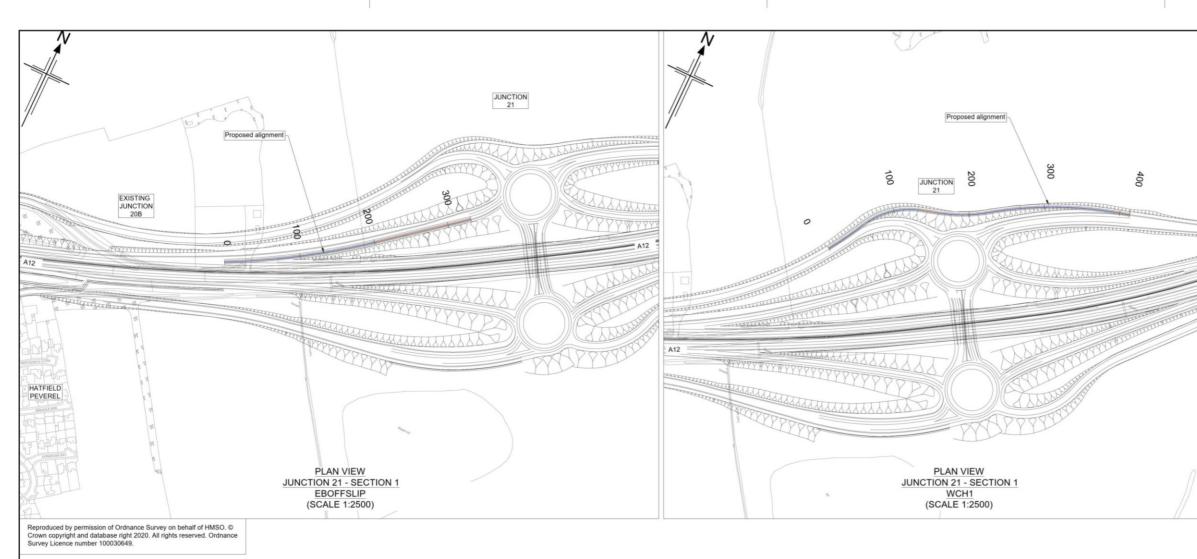


Datum: 40.00 mAOD

PROPOSED

LEVELS

GRADIENT

JUNCTION 21 - SECTION 1 - EBOFFSLIP (SCALE H=1:2500, V=1:500)

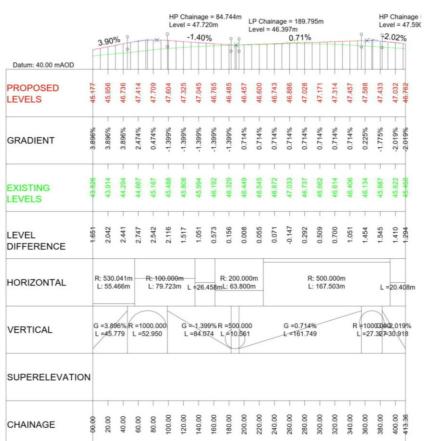


LONGITUDINAL SECTION

JUNCTION 21 - SECTION 1 - WCH1

(SCALE H=1:2500, V=1:500)

This drawing shall only be use for the design element stated in the drawing title. 2. All dimensions are in metres unless noted otherwise. 3. The base mapping is based on Ordnance Survey (O/S) Data. 4. Only written dimension shall be used. 5. For Sheet Layout Plan refer to: HE551497-JAC-HGN-SCHW-DR- C-0028 for Mainline profiles. HE551497-JAC-HGN-SCHW-DR- C-0029 for Junction profiles. HE551497-JAC-HGN-SCHW-DR- C-0030 for Sideroad profiles. PLAN Curve alignment Straight alignment Existing ground Proposed ground (constant gradient) Proposed ground (vertical curve) SCALE 1:2500 METRES SCALE 1:500 SR S2 3011213 (4) 516 17 18 19 **KEY PLAN** SCALE N.T.S. P02 20/05/21 Jacobs. COSTAIN highways england REGIONAL DELIVERY PARTNERSHIP A12 CHELMSFORD TO A120 WIDENING SCHEME PLAN AND PROFILE JUNCTION 21 SECTION 1 **EB OFFSLIP** SHEET 5 OF 5 S2 - SUITABLE FOR INFORMATION DO NOT SCALE 1:2500 P03 HE551497 - JAC - HSR--DR- C -0005 S1_J21

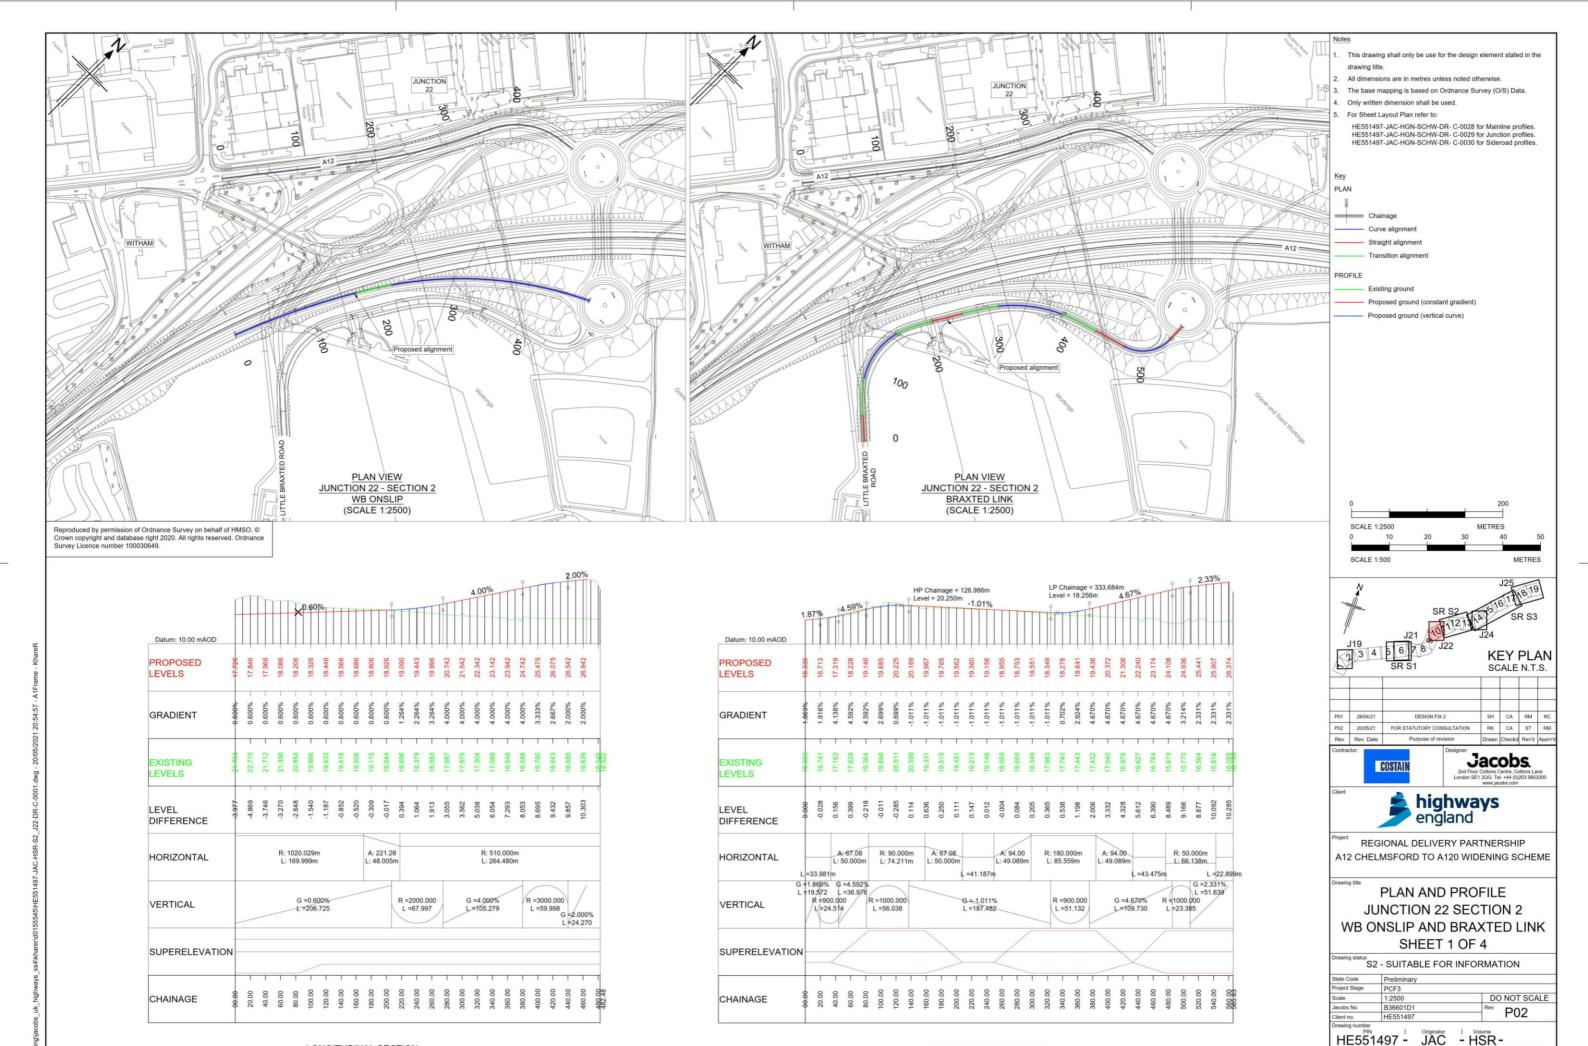


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LONGITUDINAL SECTION


JUNCTION 22 - SECTION 2 - WB ONSLIP (SCALE H=1:2500, V =1:500) LONGITUDINAL SECTION

JUNCTION 22 - SECTION 2 - BRAXTED LINK
(SCALE H=1:2500, V=1:500)

ght. Limitation: This drawing has been prepared on behalf of, and for the exclusion of the sissued in accordance with, the provisions of the contact between Jacobs and the sissued in accordance with the provisions of the contact behave Jacobs and sissued in the sissue of the sis

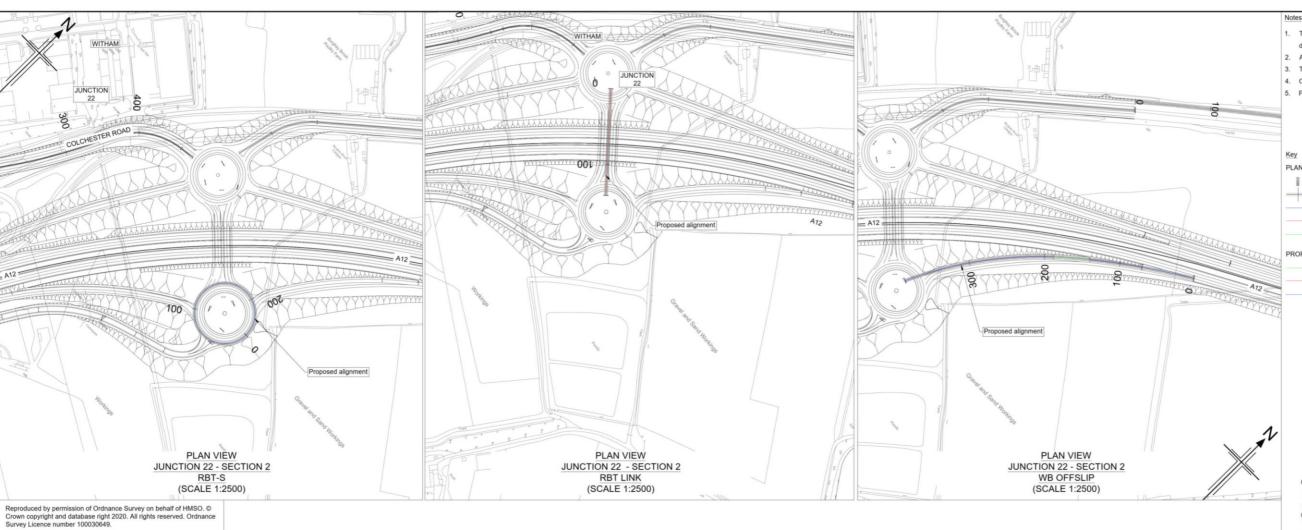

HP Chainage = 47.401m Level = 28.352m \(^-1.80\)%

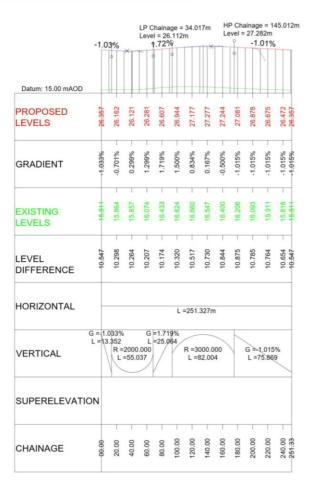

LONGITUDINAL SECTION

JUNCTION 22 - SECTION 2 - RBT-S


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Datum: 15.00 mAOD PROPOSED LEVELS GRADIENT EXISTING LEVELS LEVEL DIFFERENCE HORIZONTAL L =141.078m R =3000.000 L =94.920 VERTICAL SUPERELEVATION CHAINAGE

LONGITUDINAL SECTION JUNCTION 22 - SECTION 2 - RBT LINK (SCALE H=1:2500, V =1:500)

Datum: 10.00 mAOD PROPOSED LEVELS GRADIENT **EXISTING** LEVELS LEVEL DIFFERENCE R: 1020.000m L: 140.000m A: 221.28 HORIZONTAL L: 48.005m G =4.000% L =76.643 R =3000.000 L =59.996 G =2.000% L =14.555 VERTICAL SUPERELEVATION CHAINAGE

> JUNCTION 22 - SECTION 2 -WB OFFSLIP (SCALE H=1:2500, V =1:500)

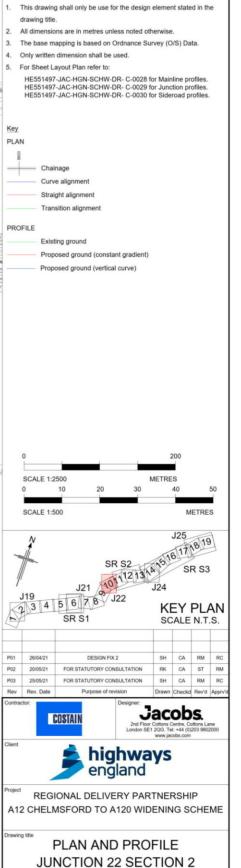

RBT-S,RBT LINK AND WB OFFSLIP SHEET 2 OF 4

S2 - SUITABLE FOR INFORMATION

HE551497 - JAC - HSR-


S2_J22


DO NOT SCALE

P03

-DR- C -0002

LONGITUDINAL SECTION

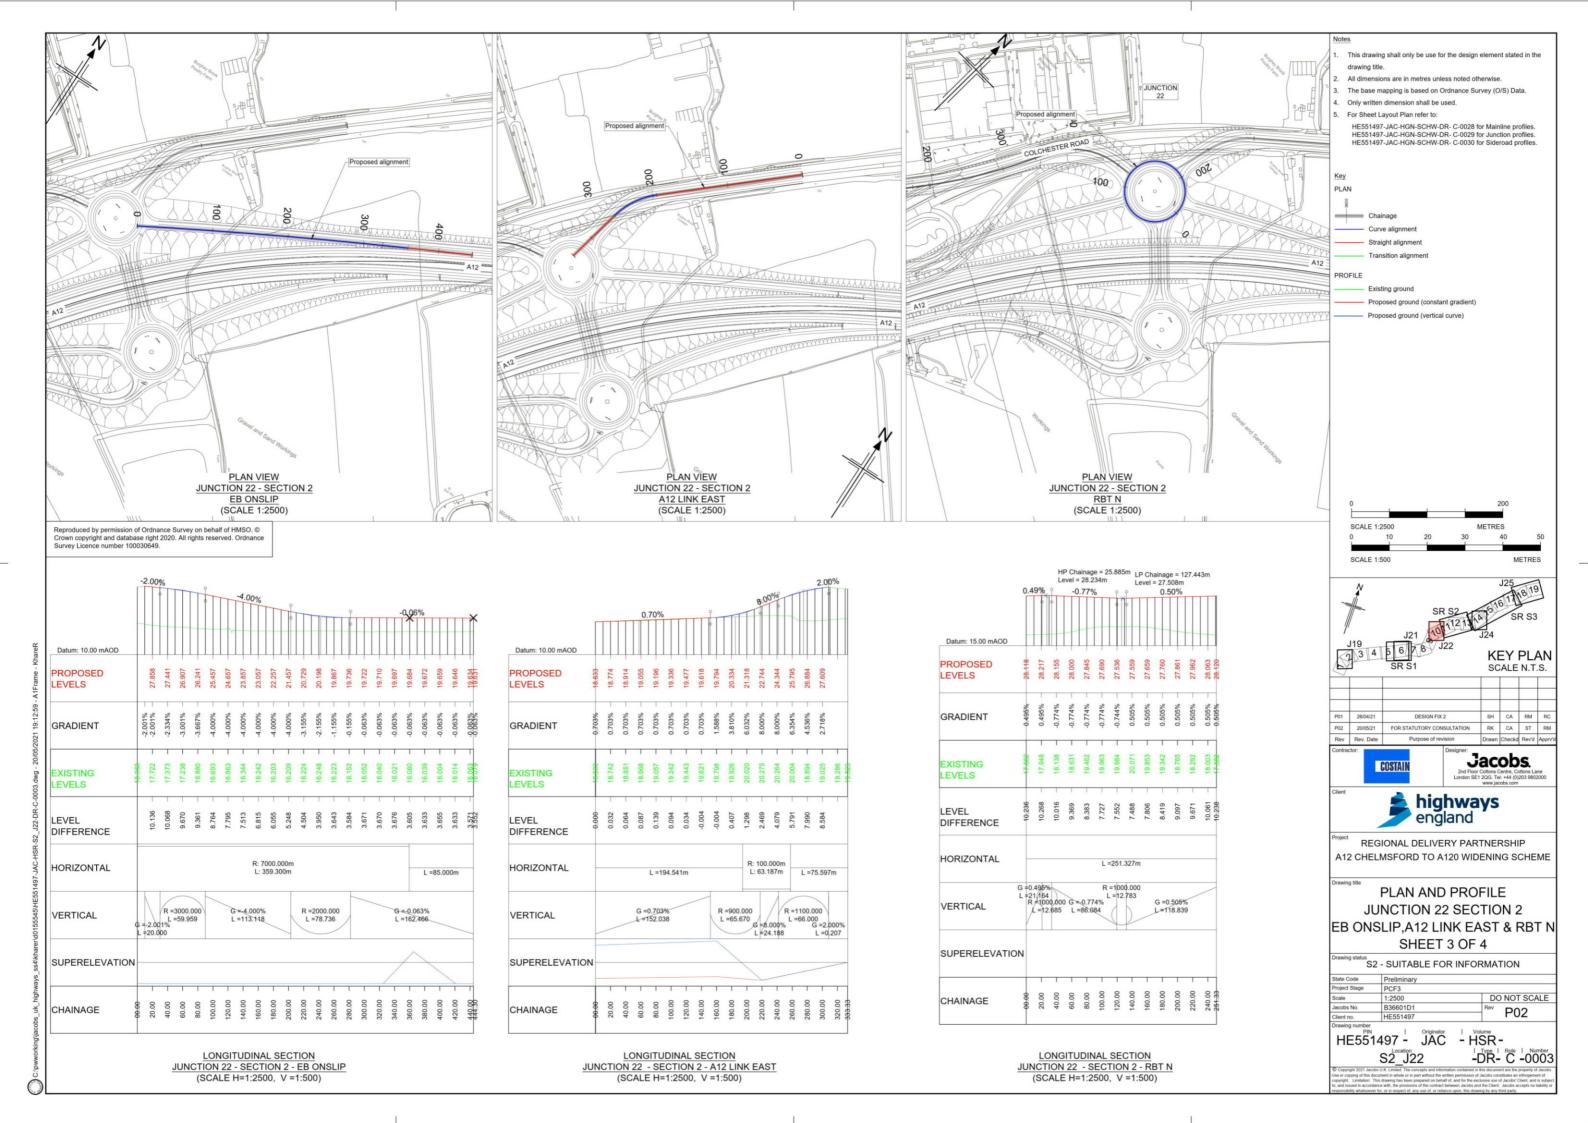


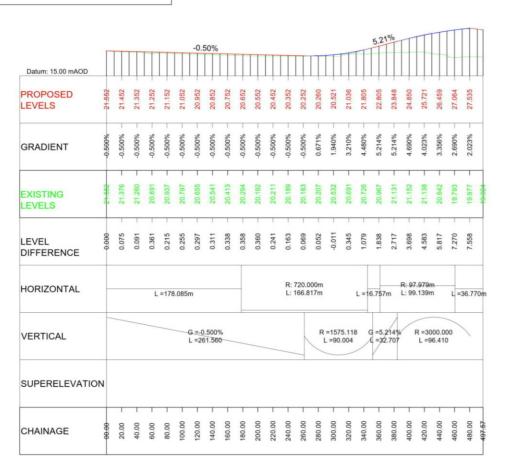

LONGITUDINAL SECTION

JUNCTION 22 - SECTION 2 - COLEMANS LINK 1

(SCALE H=1:2500, V=1:500)

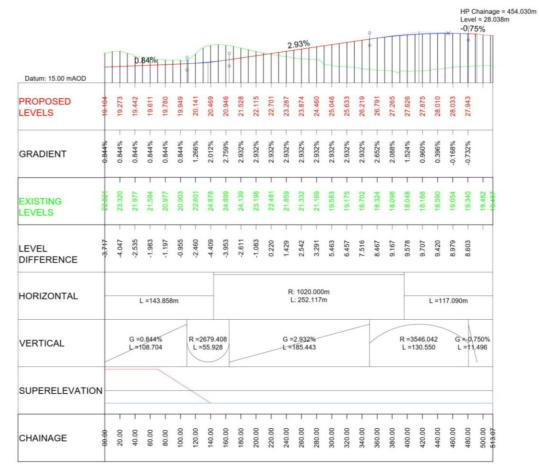


LONGITUDINAL SECTION
JUNCTION 22 - SECTION 2 - EB OFFSLIP (SCALE H=1:2500, V =1:500)

This drawing shall only be use for the design element stated in the drawing title. The base mapping is based on Ordnance Survey (O/S) Data. Only written dimension shall be used. For Sheet Layout Plan refer to: HE551497-JAC-HGN-SCHW-DR- C-0028 for Mainline profiles. HE551497-JAC-HGN-SCHW-DR- C-0029 for Junction profiles. HE551497-JAC-HGN-SCHW-DR- C-0030 for Sideroad profiles. Curve alignment Straight alignment **PROFILE** Existing ground Proposed ground (constant gradient) Proposed ground (vertical curve) SCALE 1:2500 METRES SCALE 1:500 METRES **KEY PLAN** SCALE N.T.S.
 P02
 20/05/21
 FOR STATUTORY CONSULTATION

 Rev
 Rev. Date
 Purpose of revision
 Jacobs. highways england REGIONAL DELIVERY PARTNERSHIP A12 CHELMSFORD TO A120 WIDENING SCHEME PLAN AND PROFILE **JUNCTION 22 SECTION 2** COLEMANS LINK AND EB OFFSLIP SHEET 4 OF 4 S2 - SUITABLE FOR INFORMATION 1:2500 B36601D1 HE551497 DO NOT SCALE P02

HE551497 - JAC - HSR-

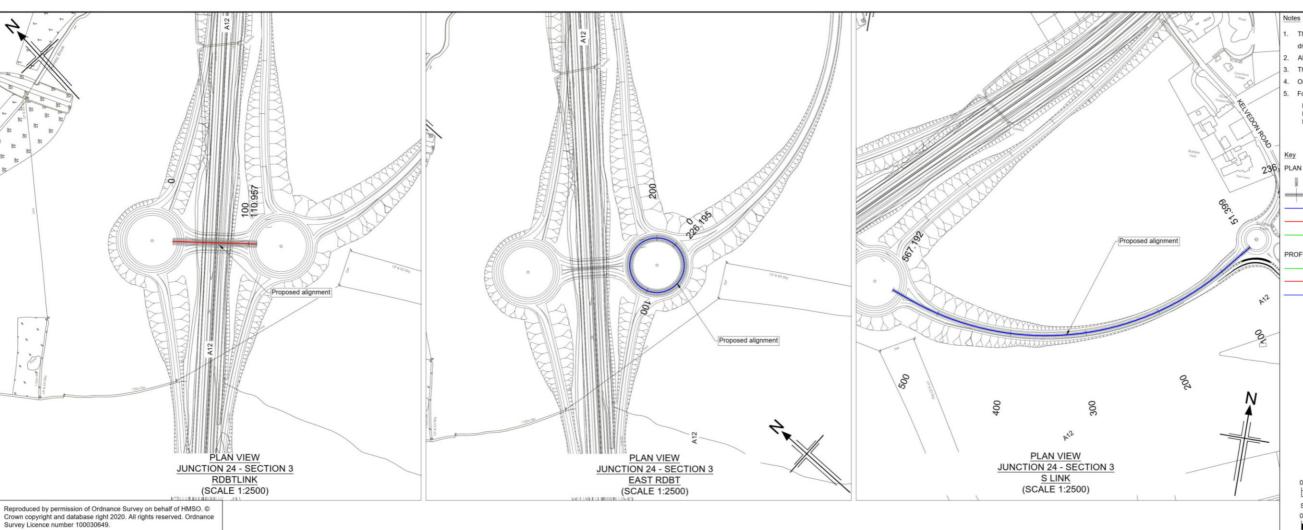

Datum: 25.00 mAOD

PROPOSED
LEVELS


GRADIENT

\$\frac{9}{2}\text{0.049\frac{9}{4}} \text{0.49\frac{9}{4}} \text{2.50\frac{9}{2}\text{0.049\frac{9}{4}}} \text{2.50\frac{9}{2}\text{0.052\frac{1}{2}\text{2.12}}} \text{2.50\frac{9}{2}\text{0.052\frac{1}{2}\text{2.12}\text{2.12}} \text{2.50\frac{9}{2}\text{0.052\frac{1}{2}\text{2.12}}} \text{2.50\frac{9}{2}\text{0.052\frac{1}{2}\text{2.12}}} \text{2.50\frac{9}{2}\text{0.052\frac{1}{2}\text{2.12}}} \tex

LONGITUDINAL SECTION

JUNCTION 24 - SECTION 3 - RDBTLINK

(SCALE H=1:2500, V=1:500)

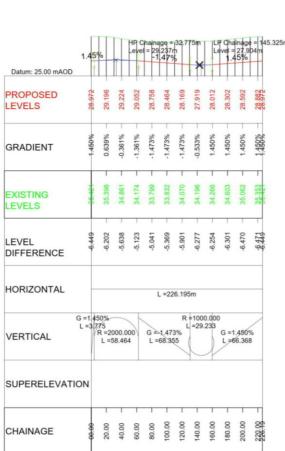

<u>JUNCTION 24 - SECTION 3 - EAST RDBT</u> (SCALE H=1:2500, V=1:500)

HP Chainage = 212.187m Level = 40.032m Datum: 25.00 mAOD PROPOSED LEVELS GRADIENT EXISTING LEVELS LEVEL DIFFERENCE R: 362.818m L: 455.907m HORIZONTAL L =24.620m G =-2.752% L =25.992 R =2000.000 R =200.000 G =2.001% L =83.965 R =3300.000 G = 5.006% L = 90.172 VERTICAL L =231 231 L =45.077 SUPERELEVATION CHAINAGE

LONGITUDINAL SECTION

JUNCTION 24 - SECTION 3 - S LINK

(SCALE H=1:2500, V=1:500)

This drawing shall only be use for the design element stated in the drawing title. The base mapping is based on Ordnance Survey (O/S) Data. Only written dimension shall be used. For Sheet Layout Plan refer to: HE551497-JAC-HGN-SCHW-DR- C-0028 for Mainline profiles. HE551497-JAC-HGN-SCHW-DR- C-0029 for Junction profiles. HE551497-JAC-HGN-SCHW-DR- C-0030 for Sideroad profiles. Straight alignment PROFILE Existing ground Proposed ground (constant gradient) roposed ground (vertical curve) SCALE 1:2500 SCALE 1:500 METRES **KEY PLAN** SCALE N.T.S.
 P02
 20/05/21
 FOR STATUTORY CONSULTATION

 Rev
 Rev. Date
 Purpose of revision
 Jacobs. highways england REGIONAL DELIVERY PARTNERSHIP A12 CHELMSFORD TO A120 WIDENING SCHEME PLAN AND PROFILE **JUNCTION 24 SECTION 3** RDBT LINK EAST RDBT S LINK SHEET 1 OF 5 S2 - SUITABLE FOR INFORMATION

DO NOT SCALE
Rev P02

-DR- C -0001

HE551497

S3 J24

HE551497 - JAC - HSR-

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Datum: 35.00 mAOD				-0.2	28%			
PROPOSED LEVELS	38.079	38.023	37.967	37.911	37.855	37.799	37,743	
GRADIENT	0.281%	-0.281%	-0.281%	-0.281%	0.281%	-0.281%	-0.281%	-0.281%
EXISTING LEVELS	38.079	37.905	37,758	37.511	37.884	37.636	37.303	87.180
LEVEL DIFFERENCE	0.000	0.119	0.209	0.400	-0.029	0.163	0.440	1
HORIZONTAL	1 -2	0.212	L	90.00 62.45			19.24	1 m
VERTICAL	173	0.212	_	3 = 0 L =13		6	19.24	
SUPERELEVATIO	ON							
CHAINAGE	00:00	20.00	40.00	00.09	80.00	100.001	120.00	140.00


LONGITUDINAL SECTION JUNCTION 24 - SECTION 3 - INWORTH S (SCALE H=1:2500, V =1:500)

	2.0	3%	1	.35%	6	-
Datum: 35.00 mAOD	-		T		1	Щ
PROPOSED LEVELS	36.263	36.669	36.958	37,228	37.498	
GRADIENT	2.028%	1.966%	1.350%	1.350%	1.350%	1.350%
	+	Т	Ţ	T	T	٦.
EXISTING LEVELS	36.263	36,725	36.828	36,669	36,478	36,646
	+		1	1	1	\dashv
LEVEL DIFFERENCE	0.000	-0.056	0.130	0.559	1.019	
HORIZONTAL		L: 40	.000r .059r	R: 4	0.000	
VERTICAL			L:	=1.35	0%	
SUPERELEVATI	ON					
	\neg	1	1	1	1	7
CHAINAGE	00:00	20.00	40.00	00.09	80.00	100.00

LONGITUDINAL SECTION JUNCTION 24 - SECTION 3 - INWORTH E (SCALE H=1:2500, V =1:500)

Datum: 35.00 mAOD	F		0.0	0%		H
PROPOSED LEVELS	37.891	37.891	37.891	37.891	37.891	37.891
GRADIENT	0.000%	0.000%	0.000%	0.000%	0.000%	0.000%
	+	Т	Т	T	1	
EXISTING LEVELS	36.95	37.461	37.746	37.460	37.030	36.932
	+		1	1		+
LEVEL DIFFERENCE	0.959	0.430	0.145	0.431	0.861	0.966
HORIZONTAL		L	=100).531	m	
VERTICAL	-		G =0. L =10			
SUPERELEVATIO	N					
CHAINAGE	90:00	20.00	40.00	- 00.09	80.00	100.00

LONGITUDINAL SECTION
JUNCTION 24 - SECTION 3 - INWORTHRDRDBT (SCALE H=1:2500, V =1:500)

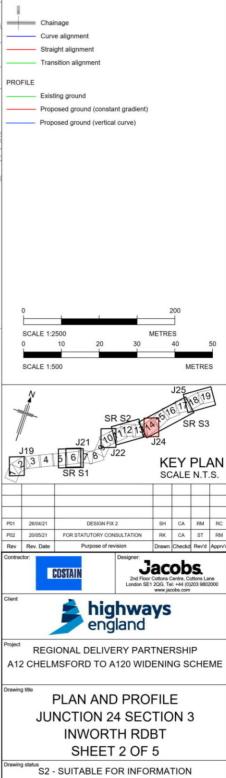

1:2500 B36601D1 HE551497

S3 J24


HE551497 - JAC - HSR -

DO NOT SCALE Rev P02



Datum: 40.00 mAOD 4.14% PROPOSED LEVELS GRADIENT LEVELS 0.430 0.666 0.690 0.742 LEVEL DIFFERENCE R: 65.000m HORIZONTAL L: 63.660m L =28.072m L =3.922m G =2.001% R =3000.000 L =64.183 G =4.140% G =2.281% L =10.329 L =8.769 VERTICAL SUPERELEVATION CHAINAGE

LONGITUDINAL SECTION JUNCTION 24 - SECTION 3 - INWORTH N (SCALE H=1:2500, V =1:500)

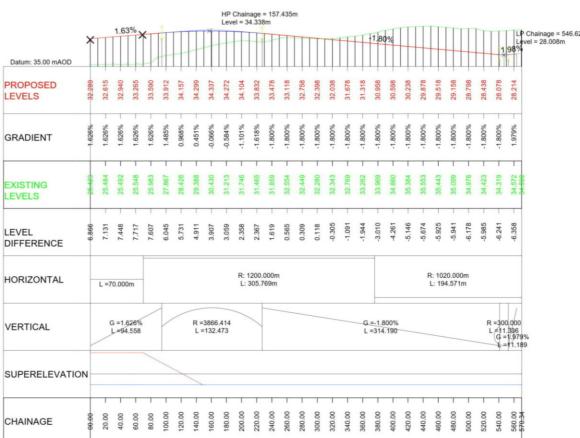

LONGITUDINAL SECTION JUNCTION 24 - SECTION 3 - WB OFFSLIP (SCALE H=1:2500, V =1:500)

This drawing shall only be use for the design element stated in the drawing title. All dimensions are in metres unless noted otherwise. 3. The base mapping is based on Ordnance Survey (O/S) Data. 4. Only written dimension shall be used. 5. For Sheet Layout Plan refer to: HE551497-JAC-HGN-SCHW-DR- C-0028 for Mainline profiles. HE551497-JAC-HGN-SCHW-DR- C-0029 for Junction profiles. HE551497-JAC-HGN-SCHW-DR- C-0030 for Sideroad profiles. Straight alignment PROFILE Existing ground Proposed ground (constant gradient) Proposed ground (vertical curve) SCALE 1:2500 SCALE 1:500 METRES **KEY PLAN** SCALE N.T.S.

 P02
 20/05/21
 FOR STATUTORY CONSULTATION

 Rev
 Rev. Date
 Purpose of revision
 Jacobs.

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REGIONAL DELIVERY PARTNERSHIP A12 CHELMSFORD TO A120 WIDENING SCHEME


PLAN AND PROFILE **JUNCTION 24 SECTION 3** INWORTH N SHEET 3 OF 5

S2 - SUITABLE FOR INFORMATION

DO NOT SCALE P02 HE551497

HE551497 - JAC - HSR-

-DR- C -0003 S3 J24

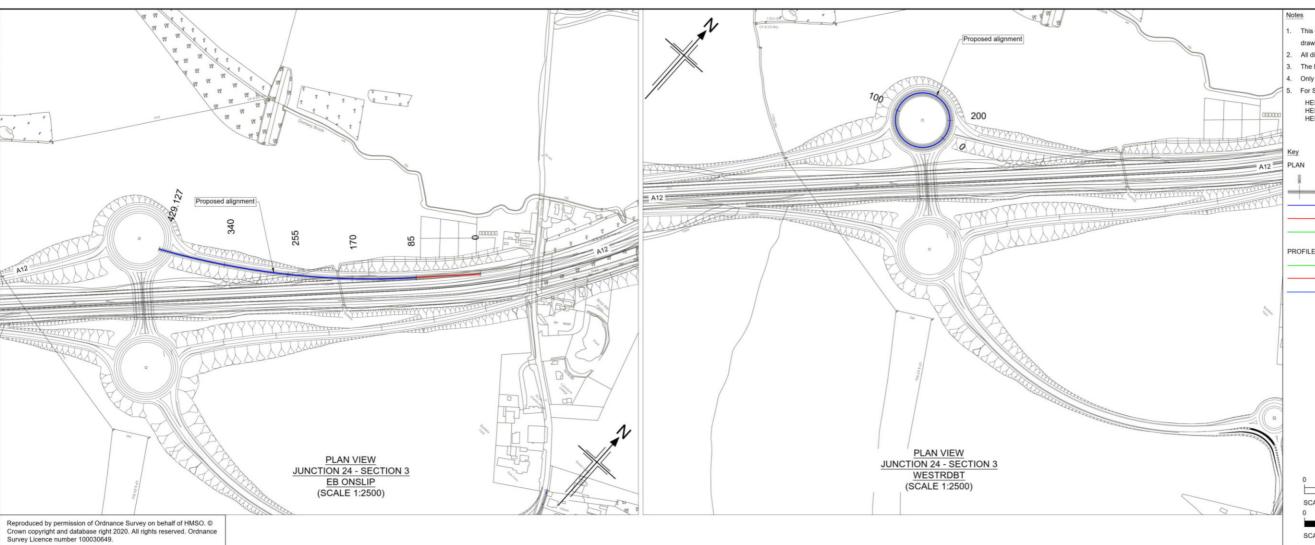

Datum: 25.00 mAOD

PROPOSED

LEVELS

GRADIENT

GRADIENT

GRADIENT

ASSOCIATION

LEVEL SESSION

ASSOCIATION

CHAINAGE

GRADIENT

R = 3700,000

L = 168.615

L = 168.615

CHAINAGE


GRADIENT

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LONGITUDINAL SECTION

JUNCTION 24 - SECTION 3 - EB ONSLIP

(SCALE H=1:2500, V=1:500)

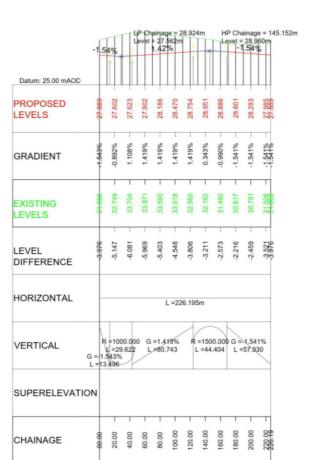


LONGITUDINAL SECTION

JUNCTION 24 - SECTION 3 - WESTRDBT

(SCALE H=1:2500, V=1:500)

This drawing shall only be use for the design element stated in the drawing title. The base mapping is based on Ordnance Survey (O/S) Data. 4. Only written dimension shall be used. For Sheet Layout Plan refer to: HE551497-JAC-HGN-SCHW-DR- C-0028 for Mainline profiles. HE551497-JAC-HGN-SCHW-DR- C-0029 for Junction profiles. HE551497-JAC-HGN-SCHW-DR- C-0030 for Sideroad profiles. Straight alignment **PROFILE** Existing ground Proposed ground (constant gradient) Proposed ground (vertical curve) SCALE 1:2500 SCALE 1:500 METRES **KEY PLAN** SCALE N.T.S.
 P02
 20/05/21
 FOR STATUTORY CONSULTATION


 Rev
 Rev. Date
 Purpose of revision
 Jacobs. highways england REGIONAL DELIVERY PARTNERSHIP A12 CHELMSFORD TO A120 WIDENING SCHEME PLAN AND PROFILE **JUNCTION 24 SECTION 3** WESTRDBT SHEET 4 OF 5 S2 - SUITABLE FOR INFORMATION DO NOT SCALE P02 HE551497 HE551497 - JAC - HSR--DR- C -0004 S3 J24

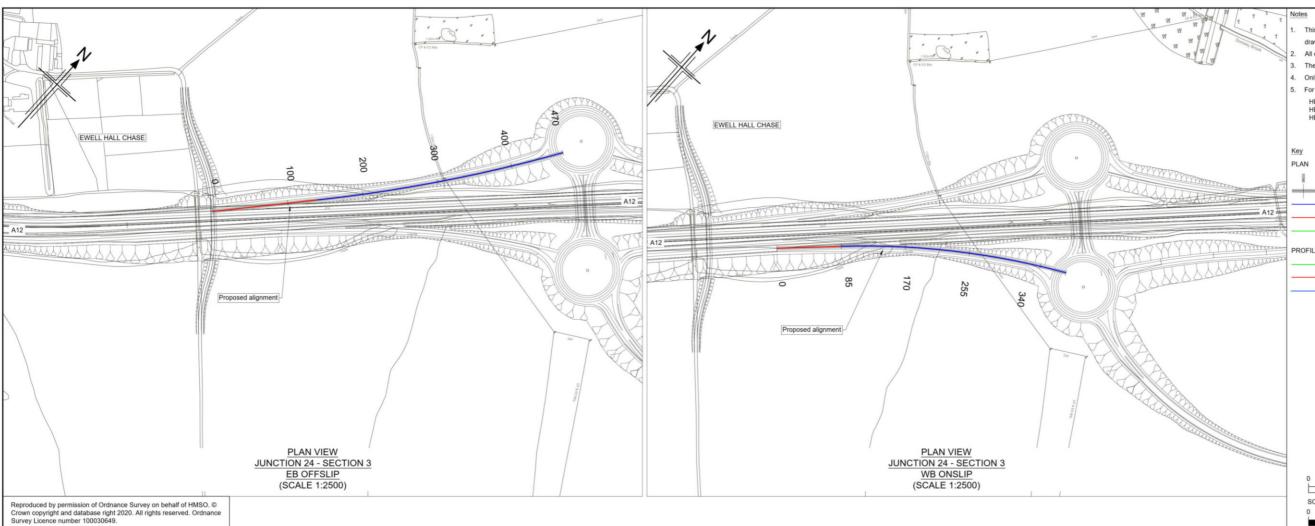

LONGITUDINAL SECTION

JUNCTION 24 - SECTION 3 - EB OFFSLIP

(SCALE H=1:2500, V=1:500)

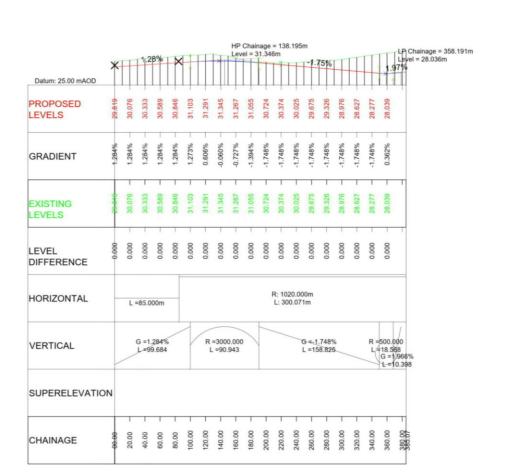


LONGITUDINAL SECTION

JUNCTION 24 - SECTION 3 - WB ONSLIP


(SCALE H=1:2500, V=1:500)

This drawing shall only be use for the design element stated in the drawing title. The base mapping is based on Ordnance Survey (O/S) Data. 4. Only written dimension shall be used. 5. For Sheet Layout Plan refer to: HE551497-JAC-HGN-SCHW-DR- C-0028 for Mainline profiles. HE551497-JAC-HGN-SCHW-DR- C-0029 for Junction profiles. HE551497-JAC-HGN-SCHW-DR- C-0030 for Sideroad profiles. Straight alignment **PROFILE** Existing ground Proposed ground (constant gradient) Proposed ground (vertical curve) SCALE 1:2500 METRES SCALE 1:500 METRES **KEY PLAN** SCALE N.T.S.
 P02
 20/05/21
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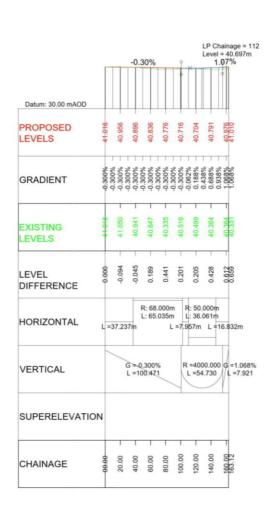
 Rev
 Rev. Date
 Purpose of revision
 Jacobs. highways england REGIONAL DELIVERY PARTNERSHIP A12 CHELMSFORD TO A120 WIDENING SCHEME PLAN AND PROFILE **JUNCTION 24 SECTION 3** EB OFFSLIP WB ONSLIP SHEET 5 OF 5 S2 - SUITABLE FOR INFORMATION DO NOT SCALE P02 HE551497 HE551497 - JAC - HSR--DR- C -0005

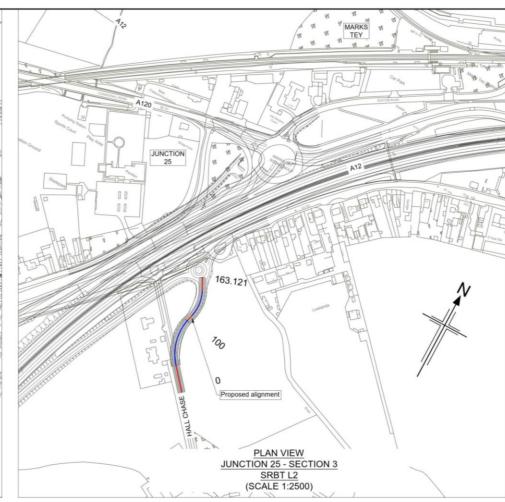

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LONGITUDINAL SECTION JUNCTION 25 - SECTION 3 - WB MERGE (SCALE H=1:2500, V =1:500)

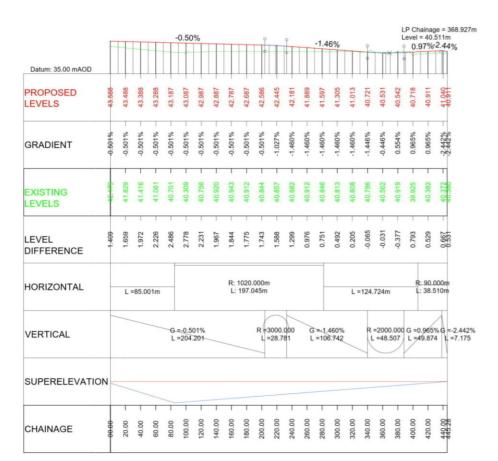

LONGITUDINAL SECTION JUNCTION 25 - SECTION 3 - SRBT L2 (SCALE H=1:2500, V =1:500)

This drawing shall only be use for the design element stated in the drawing title. All dimensions are in metres unless noted otherwise. 3. The base mapping is based on Ordnance Survey (O/S) Data. 4. Only written dimension shall be used. 5. For Sheet Layout Plan refer to: HE551497-JAC-HGN-SCHW-DR- C-0028 for Mainline profiles. HE551497-JAC-HGN-SCHW-DR- C-0029 for Junction profiles. HE551497-JAC-HGN-SCHW-DR- C-0030 for Sideroad profiles. PLAN Curve alignment Straight alignment Transition alignment **PROFILE** Existing ground Proposed ground (constant gradient) Proposed ground (vertical curve) SCALE 1:2500 SCALE 1:500 METRES **KEY PLAN** SCALE N.T.S.
 P02
 20/05/21
 FOR STATUTORY CONSULTATION

 Rev
 Rev. Date
 Purpose of revision
 Jacobs. highways england


REGIONAL DELIVERY PARTNERSHIP A12 CHELMSFORD TO A120 WIDENING SCHEME


PLAN AND PROFILE **JUNCTION 25 SECTION 3** WB MERGE AND SRBT L2 SHEET 1 OF 7

S2 - SUITABLE FOR INFORMATION


State Code	Preliminary	
Project Stage	PCF3	
Scale	1:2500	DO NOT SCALE
Jacobs No.	B36601D1	Rev DO2
Client no.	HE551497	P02

HE551497 - JAC - HSR--DR- C -0001 S3 J25

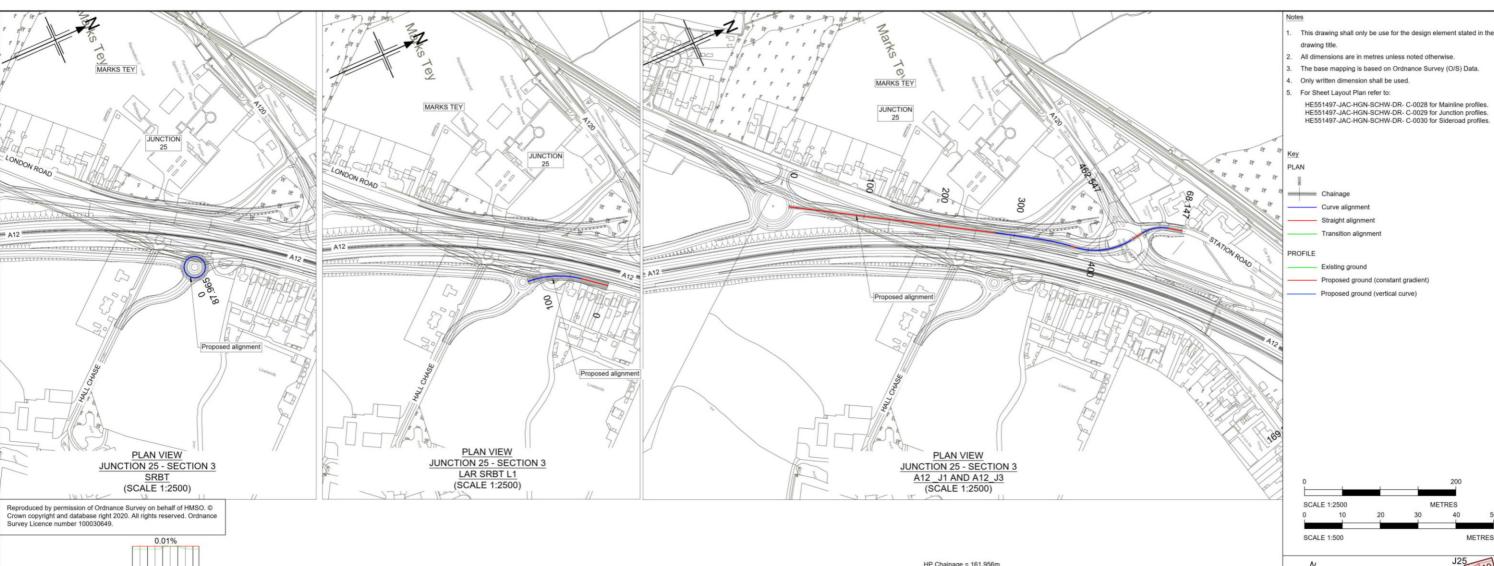

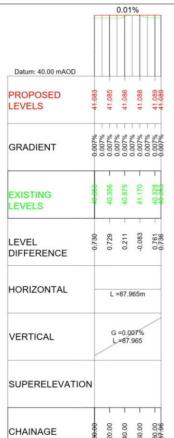


LONGITUDINAL SECTION
JUNCTION 25 - SECTION 3 - SRBT
(SCALE H=1:2500, V=1:500)

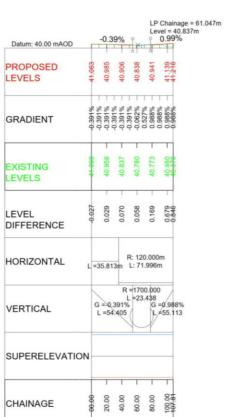

LONGITUDINAL SECTION

JUNCTION 25 - SECTION 3 - LAR SRBT L1


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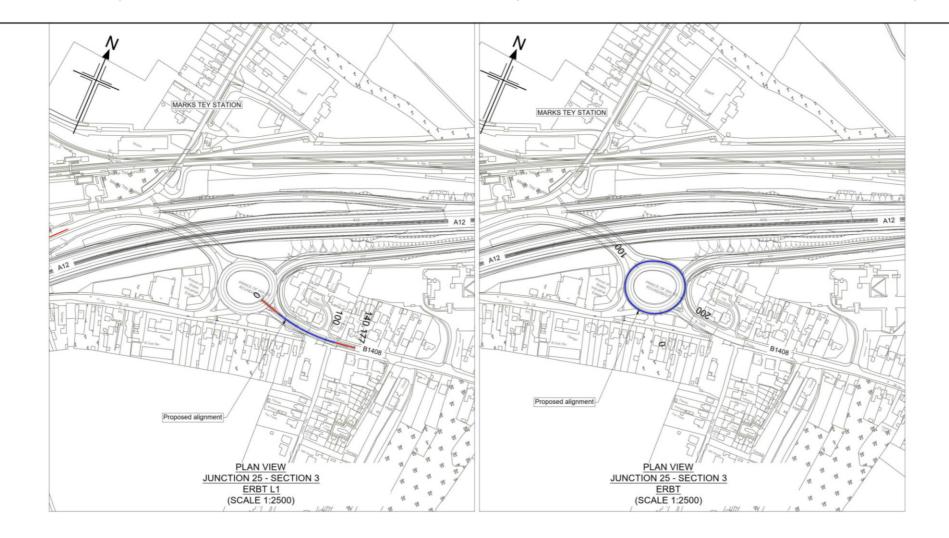

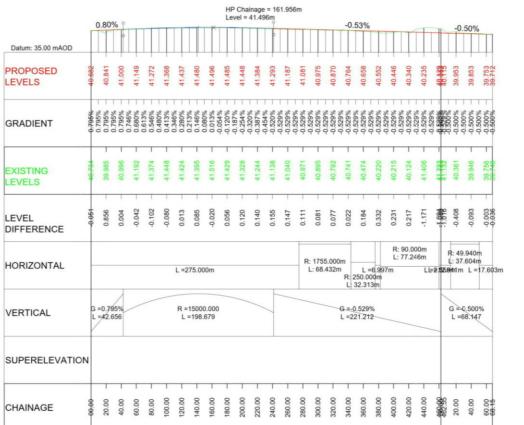
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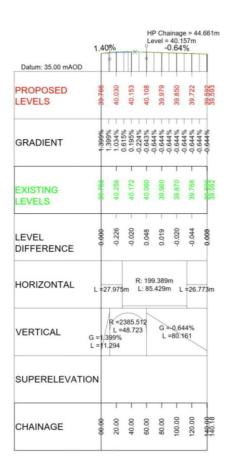
JUNCTION 25 - SECTION 3 - A12 J1 AND A12 J3

(SCALE H=1:2500, V=1:500)



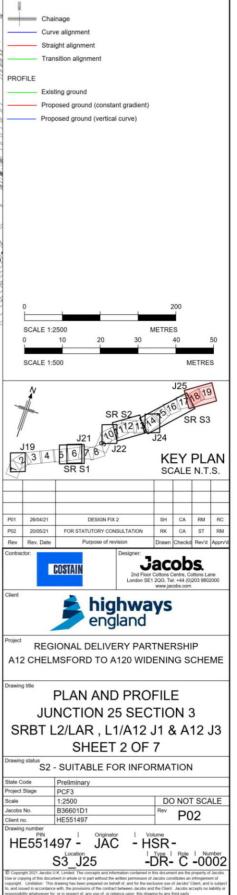


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LONGITUDINAL SECTION

JUNCTION 25 - SECTION 3 - ERBT L1


(SCALE H=1:2500, V=1:500)





LONGITUDINAL SECTION

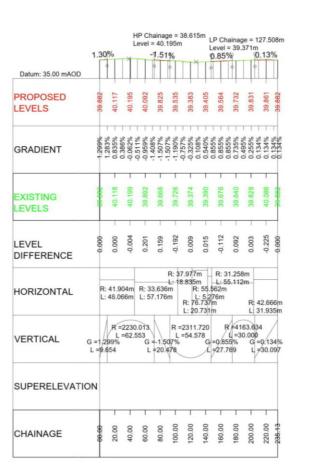
JUNCTION 25 - SECTION 3 - ERBT

(SCALE H=1:2500, V=1:500)

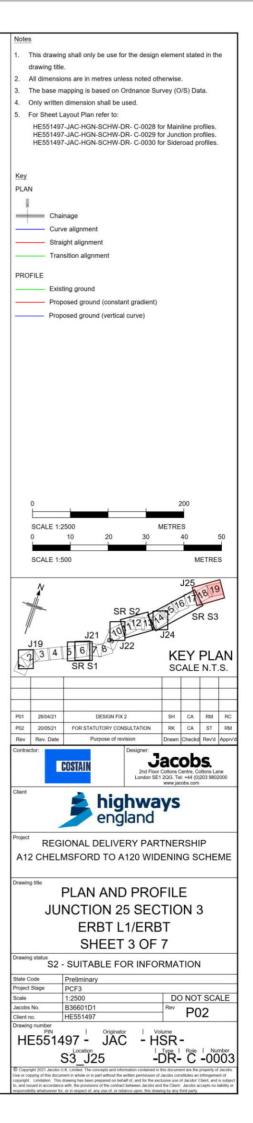

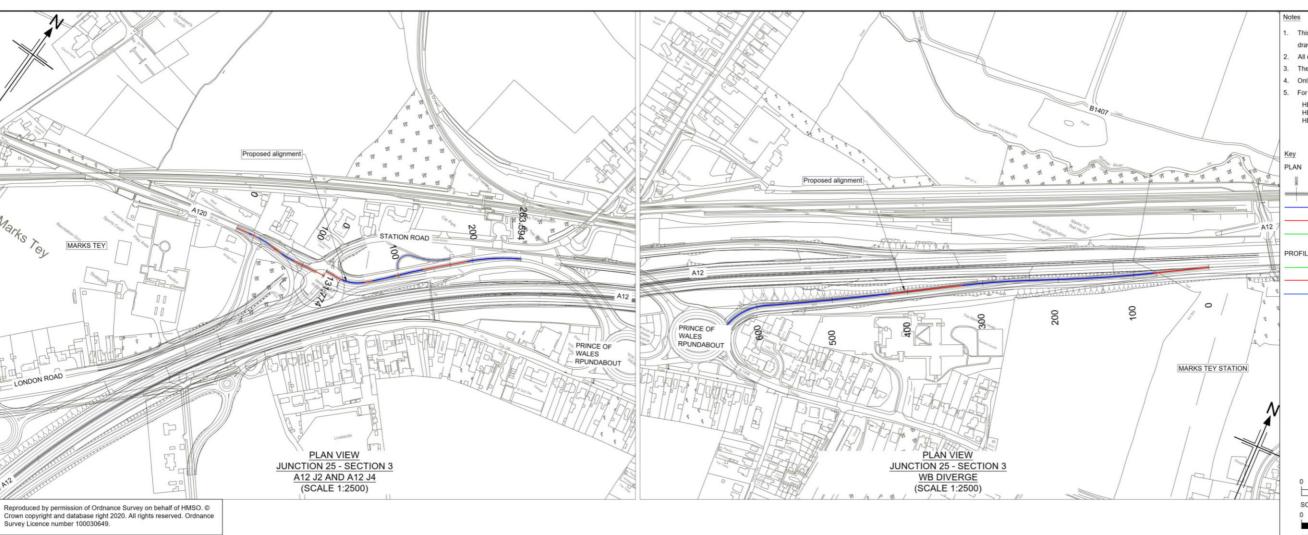


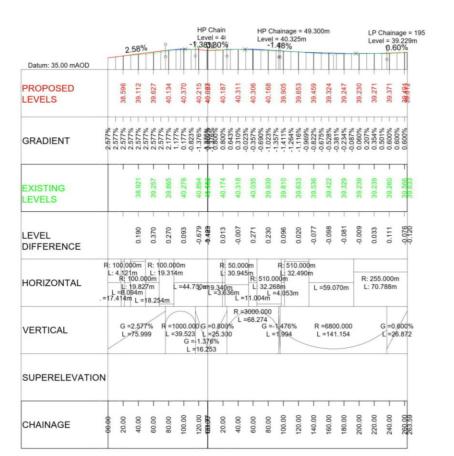

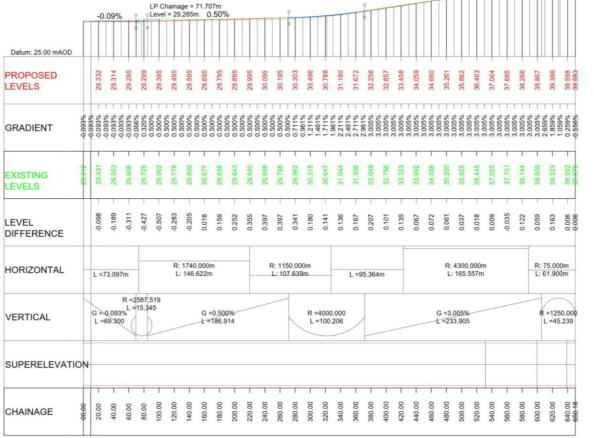

JUNCTION 25 - SECTION 3 - WB DIVERGE

LONGITUDINAL SECTION (SCALE H=1:2500, V =1:500)

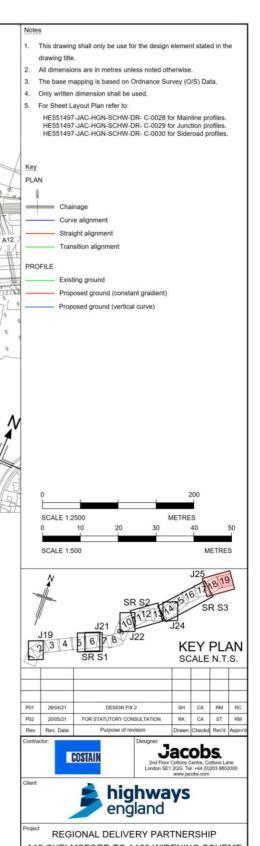

A12 CHELMSFORD TO A120 WIDENING SCHEME

PLAN AND PROFILE **JUNCTION 25 SECTION 3** A12 J2 AND A12 J4/WB DIVERGE SHEET 4 OF 7

S2 - SUITABLE FOR INFORMATION

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HE551497	- P02
HE55149/	. 02


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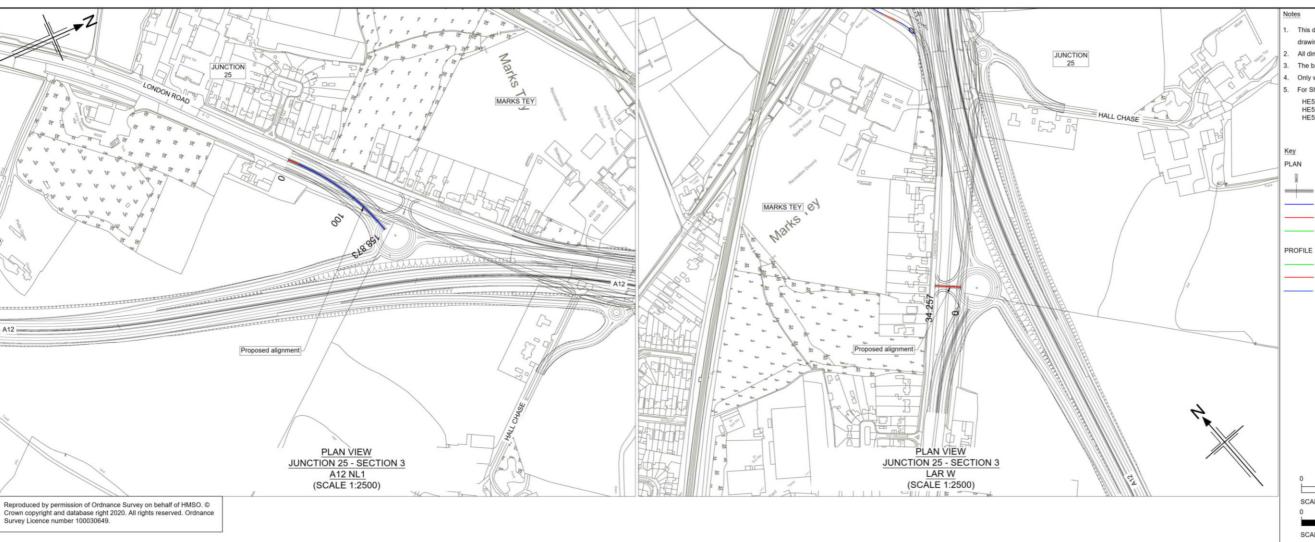
-DR- C -0004 S3 J25


LONGITUDINAL SECTION

JUNCTION 25 - SECTION 3 - A12 J2 AND A12 J4


(SCALE H=1:2500, V =1:500)



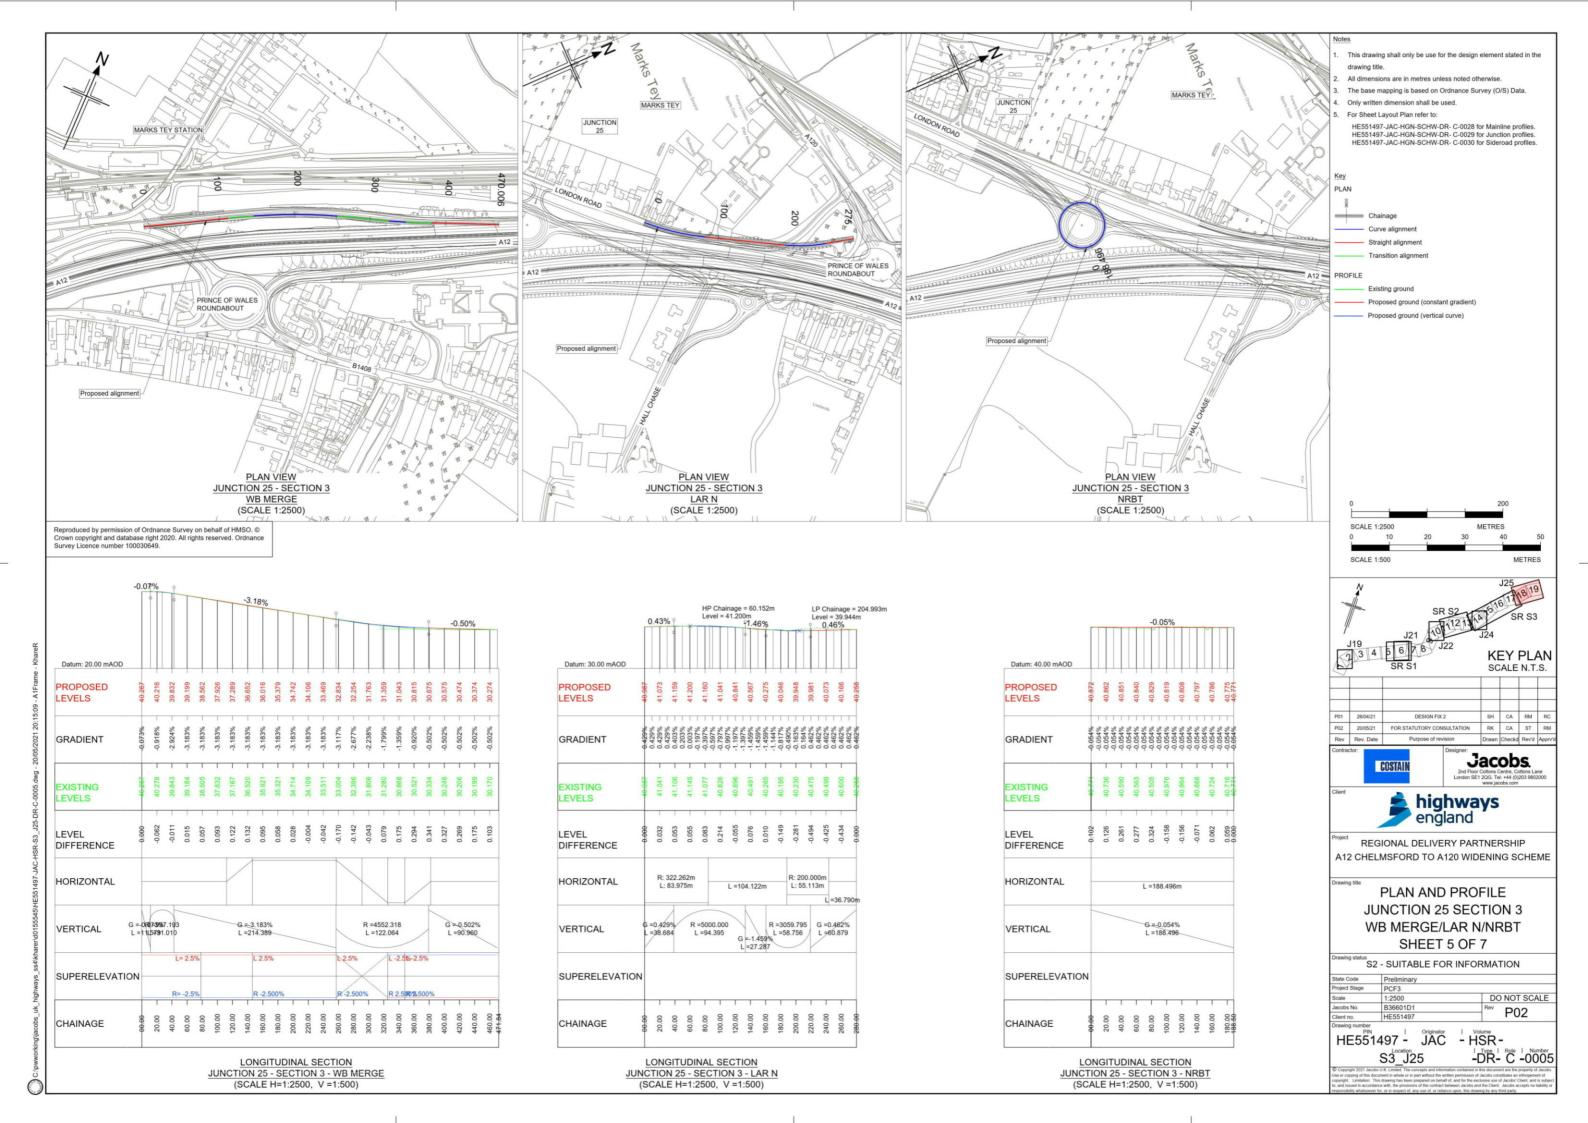

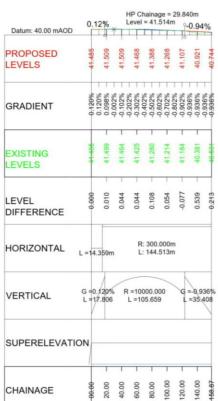

LONGITUDINAL SECTION JUNCTION 25 - SECTION 3 - A12 NL1 (SCALE H=1:2500, V =1:500)

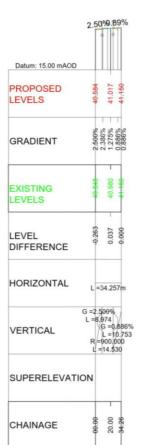

LONGITUDINAL SECTION JUNCTION 25 - SECTION 3 - LAR W (SCALE H=1:2500, V =1:500)

- This drawing shall only be use for the design element stated in the drawing title.
 - All dimensions are in metres unless noted otherwise.
 - The base mapping is based on Ordnance Survey (O/S) Data.
 - Only written dimension shall be used.
 - For Sheet Layout Plan refer to:

HE551497-JAC-HGN-SCHW-DR- C-0028 for Mainline profiles. HE551497-JAC-HGN-SCHW-DR- C-0029 for Junction profiles. HE551497-JAC-HGN-SCHW-DR- C-0030 for Sideroad profiles.

Straight alignment

Existing ground Proposed ground (constant gradient)

Proposed ground (vertical curve)

SCALE 1:2500 SCALE 1:500 METRES

KEY PLAN SCALE N.T.S.
 P02
 2005/21
 FOR STATUTORY CONSULTATION
 RK
 CA
 ST
 RM

 Rev
 Rev. Date
 Purpose of revision
 Drawn Checkd
 Rev'd
 Approv

Jacobs.




REGIONAL DELIVERY PARTNERSHIP A12 CHELMSFORD TO A120 WIDENING SCHEME

> PLAN AND PROFILE **JUNCTION 25 SECTION 3** A12 NL1/LAR W SHEET 6 OF 7


S2 - SUITABLE FOR INFORMATION

DO NOT SCALE P02 HE551497

HE551497 - JAC - HSR-S3 J25

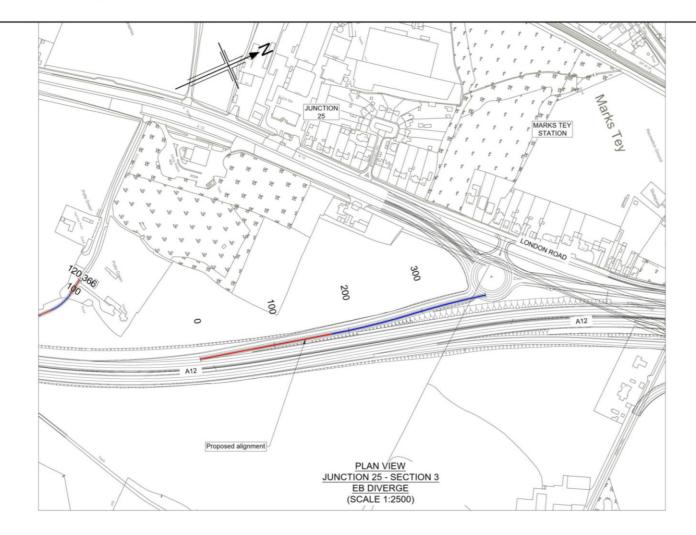

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LONGITUDINAL SECTION

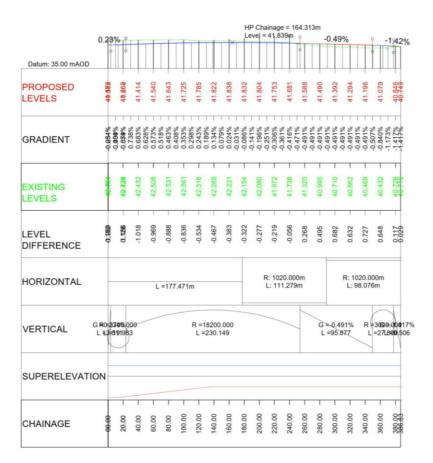JUNCTION 25 - SECTION 3 - EB DIVERGE
(SCALE H=1:2500, V=1:500)

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 P02
 20/05/21
 FOR STATUTORY CONSULTATION

 Rev
 Rev. Date
 Purpose of revision
 Jacobs. highways england REGIONAL DELIVERY PARTNERSHIP A12 CHELMSFORD TO A120 WIDENING SCHEME PLAN AND PROFILE **JUNCTION 25 SECTION 3 EB DIVERGE** SHEET 7 OF 7 S2 - SUITABLE FOR INFORMATION 1:2500 B36601D1 HE551497 DO NOT SCALE P02 HE551497 - JAC - HSR--DR- C -0007 S3 J25

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